

EMPIRE STATE DEVELOPMENT

LONGSHED INTERIOR RENOVATIONS

LOCATION MAP

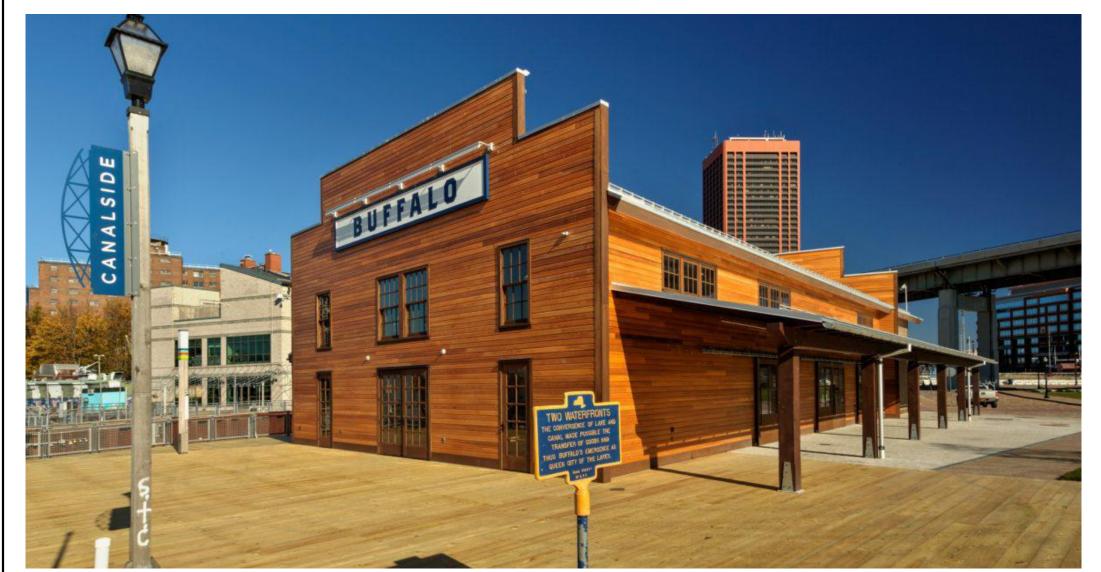

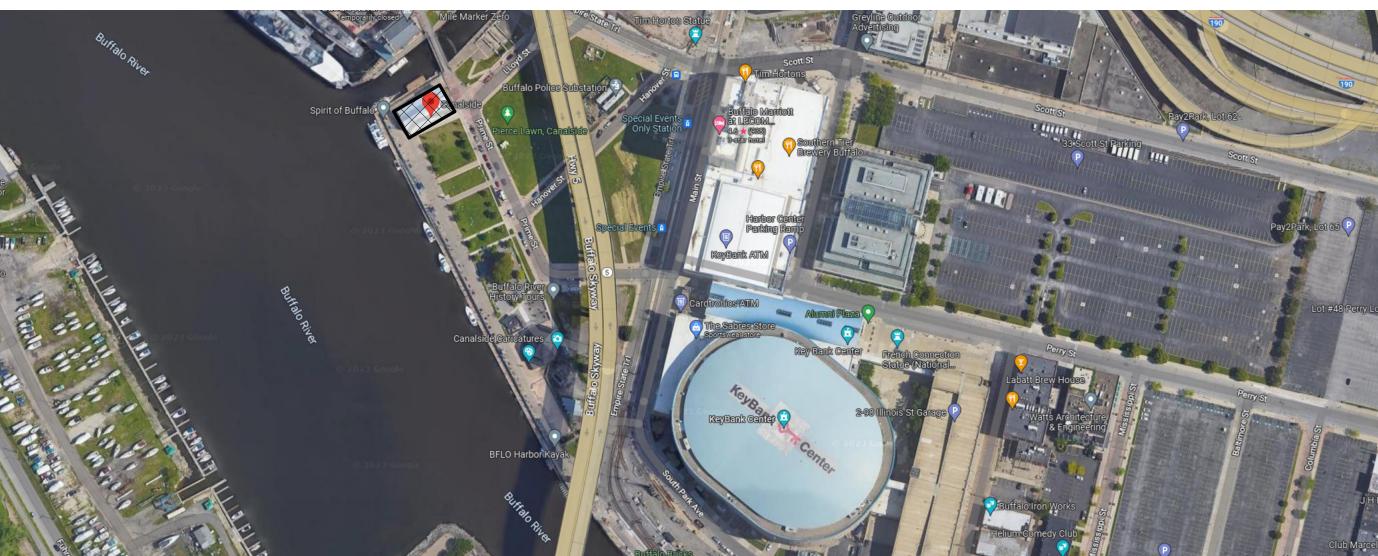

RUBBER BASE

ROOF DRAIN

RECESSED

REFERENCE

RESILIENT

REVISION

ROOM

RIGHT HAND

ROOF LEADER

ROUGH OPENING

RIGHT OF WAY

ROOF TOP UNIT

ROOF VENT

RIGHT HAND REVERSE

RECPT RECEPTACLE

REINF REINFORCING

REQD REQUIRED

RES

RTU

REFLECTED CEILING PLAN

PROJECT LOCATION

CANALSIDE 44 PRIME ST BUFFALO, NY 14202



Signature & Seal:



ARCHITECTS / ENGINEERS

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TrautmanAssociates.com

EMPIRE STATE DEVELOPMENT

RENOVATIONS

CANALSIDE **Project Address:**

44 PRIME ST. BUFFALO, NY 14202

Drawing History: # Date Description

6. JOB SITE — EACH CONTRACTOR SHALL KEEP THE JOB SITE FREE O SIDEWALKS SHALL BE KEPT FREE OF DEBRIS. TRASH CONTAINERS SHALL BE

7. PROTECTION AND RESTORATION — ALL CONTRACTORS AND THEIR SUBCONTRACTORS SHALL PROTECT AND NOT DAMAGE EXISTING FINISHES, EQUIPMENT, PROPERTY, ETC. DURING THE WORK, ALL DAMAGED AREAS SHALL BE REPAIRED/RESTORED TO THEIR ORIGINAL CONDITIONS.

AND/OR UNEVEN CONDITIONS, PATCH, LEVEL, AND FEATHER AREAS AS REQUIRED TO PROVIDE UNIFORMITY OF NEW CONSTRUCTION.

8. FACILITY OPERATIONS — CARE SHALL BE TAKEN TO AVOID DISTURBANCE OF ADJACENT FUNCTIONS/BUILDINGS. ALL WORK, DELIVERIES AND OTHER CONSTRUCTION RELATED ACTIVITIES SHALL ADHERE IN STRICT AT THE JOB SITE AT ALL TIMES FOR REVIEW.

9. QUALITY — ALL CONTRACTORS SHALL PROVIDE ALL MATERIALS INDICATED GRAPHICALLY OR AS NOTED. ALL MATERIALS USED IN CONSTRUCTION SHALL BE NEW AND FREE FROM DEFECTS. INSTALL ALL MATERIALS TO THE MANUFACTURERS'S RECOMMENDATIONS AND TO ACCEPTABLE PROFESSIONAL TRADE INDUSTRY STANDARDS FOR WORK OF SIMILAR SCOPE AND CHARACTER. WORK SHALL NOT VOID ANY WARRANTIES OR

ALL WORK OF THE PROJECT SHALL BE PERFORMED CAREFULLY AND

10. DRAWINGS — DO NOT SCALE DRAWINGS. ALL WALL, PARTITION, AND STRUCTURAL DIMENSIONS ARE ACTUAL AND ARE DIMENSIONED TO THE FACE OF THE PARTITION, UNLESS INDICATED OTHERWISE. ALL DIMENSIONS, NOTES, AND DETAILS SHOWING A PORTION OF A DRAWING SHALL APPLY TYPICALLY TO ALL OPPOSITE HAND AND/OR SIMILAR CONDITIONS. CONTRACTORS SHALL VERIFY ALL DIMENSIONS IN THE FIELD AS REQUIRED FOR THE SCOPE OF WORK AND NOTIFY THE ARCHITECT OF ANY

11. INCIDENTAL BLOCKING — PROVIDE ALL INCIDENTAL WOOD BLOCKING AS REQUIRED FOR ATTACHMENT OF FINISHES, AND ACCESSORIES, INCLUDING

12. INSPECTIONS — CONTRACTORS SHALL BE RESPONSIBLE FOR MAKING

13. OWNER-PROVIDED EQUIPMENT — ALL CONTRACTORS SHALL OBTAIN ALL REQUIREMENTS FOR INSTALLATION OF OWNER PROVIDED EQUIPMENT FROM

14. HAZARDOUS MATERIALS — TESTING WAS PERFORMED PRIOR TO THE PROJECT TO IDENTIFY HAZARDOUS MATERIALS THAT MAY BE DISTURBED BY

ABBREVIATIONS:

COND CONDENSER

CONF CONFERENCE

CONT CONTINUOUS

COORD COORDINATE

CT CERAMIC TILE

DETAIL

CTR CENTER

DIAG

CONST CONSTRUCTION

CORR CORRIDOR / CORRUGATED

DEMO DEMOLISH / DEMOLITION

DOUBLE HUNG

DIAMETER

DIAGONAL

DIFFUSER

DIMENSION

DRINKING FOUNTAIN

	DIVENIA HONO.				
AB	ANCHOR BOLT	DISP	DISPENSER	IP	IRON PIPE
ABV	ABOVE	DL	DEAD LOAD		
A/C	AIR CONDITIONING	DN	DOWN	JAN	JANITOR
ACT	ACOUSTICAL TILE OR PANEL	DR	DOOR	JST	JOIST
ADA	AMERICANS W/ DISABILITIES ACT	DS	DOWN SPOUT	JT	JOINT
ADD	ADDENDUM	DWG	DRAWING	LAD	LABORATORY
AFF	ABOVE FINISHED FLOOR	_^	FAOU	LAB	LABORATORY
AFG AHU	ABOVE FINISHED GRADE AIR HANDLING UNIT	EA EC	EACH ELECTRICAL CONTRACTOR	LAM LAV	LAMINATED LAVATORY
AL	ALUMINUM	EF EF	EXHAUST FAN / EACH FACE	LAV	POUND
ALT	ALTERNATE / ALTERNATIVE	EIFS	EXTERIOR INSULATION &	LF	LINEAR FEET / LINEAR FEET
ANOD	ANODIZED	LII O	FINISH SYSTEM	LG	LONG
	(APPROXIMATE	EJ	EXPANSION JOINT	LH	LEFT HAND
ARCH	ARCHITECT / ARCHITECTURAL	EL	ELEVATION	LHR	LEFT HAND REVERSE
ASSY	ASSEMBLY		ELECTRICAL	LIN	LINEAR
ASTM	AMERICAN SOCIETY FOR TESTING &	ELEV	ELEVATOR	LKR	LOCKER
	MATERIALS	ENCL	ENCLOSURE	LLH	LONG LEG HORIZONTAL
AV	AUDIO VISUAL	EP	ELECTRICAL PANEL	LLV	LONG LEG VERTICAL
AWG	AMERICAN WIRE GAUGE	EPDM	ETHYLENE PROPYLENE DIENE MONOMER	LL	LIVE LOAD
		EQ	EQUAL	LOC	LOCATION
BC	BUILDING CODE	EQUIP	EQUIPMENT	LP	LOW POINT
BD	BOARD	EXIST	EXISTING	LT	LIGHT
BFF	BELOW FINISH FLOOR	EXP	EXPANSION	LVR	LOUVER
BITUM	BITUMINOUS	EXT	EXTERIOR	1441/	*****
BKSPL	BACKSPLASH	EXTR	EXTRUDED / EXTRUSION	MAX	MAXIMUM
BLDG	BUILDING	FOLL	FAN COULTINIT	MB	MACHINE BOLT
BLK BLKG	BLOCK BLOCKING	FCU FD	FAN COIL UNIT FLOOR DRAIN	MC MECH	MECHANICAL CONTRACTOR
BLNG	BEAM / BENCH MARK	FDN	FOUNDATION	MED	MECHANICAL MEDIUM
BOS	BOTTOM OF STEEL	FDIN	FOUNDATION	MET	METAL
BTWN	BETWEEN	FE	FIRE EXTINGUISHER	MEZZ	MEZZANINE
BTM	BOTTOM	FF	FINISHED FLOOR	MFG	MANUFACTURING
BTU	BRITISH THERMAL UNIT	FF&E	FURNITURE, FIXTURE, & EQUIPMENT	MFR	MANUFACTURER
BUR	BUILTUP ROOF	FIN	FINISH	MH	MANHOLE
		FLR	FLOOR	MHT	MOUNTING HEIGHT
CAB	CABINET	FLM	FLOOR MAT	MIN	MINIMUM
CB	CATCH BASIN	FOS	FACE OF STUD	MISC	MISCELLANEOUS
CEM	CEMENT	FOW	FACE OF WALL	ML	MATCH LINE
CG	CORNER GUARD	FR	FRAME		
CGT	CERAMIC GLAZED TILE	FT	FEET / FOOT	N	NORTH
CJ	CONTROL JOINT	FTG	FOOTING	NA	NOT APPLICABLE
CL	CENTERLINE	FURR	FURRING	NIC	NOT IN CONTRACT
CLG	CEILING	FV	FIELD VERIFY	NOM	NOMINAL NOISE PER IOTION COEFFICIE
CLO	CLOSET	0	242	NRC	NOISE REDUCTION COEFFICIE
CLR	CLEAR	G CA	GAS	NTS	NOT TO SCALE
CLS CMT	CLOSURE CERAMIC MOSAIC TILE	GA GALV	GAUGE GALVANIZED	ОС	ON CENTER
CMU	CONCRETE MASONRY UNIT	GALV	GRAB BAR / GRADE BEAM	OFCI	OWNER FURNISHED-CONTRA
CO	CLEANOUT	GC	GENERAL CONTRACTOR	OH	OVERHEAD
COL	COLUMN	GL	GLASS	OPG	OPENING
COMB	COMBINATION	GND	GROUND	OPP	OPPOSITE
CONC	CONCRETE	GR	GRADE	OPH	OPPOSITE HAND

GYPSUM WALL BOARD

HOSE BIB

HFIGHT

INTERIOR

INVERT

INT

INV

HANDICAPPED

HOLLOW METAL

HIGH POINT / HORSEPOWER

INTERNATIONAL BUILDING CODE

INSULATED METAL PANEL

INCLUDING / INCLUDED

INSULATION / INSULATED

HVAC HEATING, VENTILATING, AIR CONDITIONING PSF

SQUARE FOOT / SQUARE FEET SHEET SIMILAR SPACE / STAND PIPE SPECS SPECIFICATIONS ONTRACTOR SQ SQUARE STAINLESS STEEL STORM DRAINAGE LINE SOUND TRANSMISSION COEFFICIENT STD STANDARD STEEL STRUCT STRUCTURAL SUSP SUSPENDED SYM SYMMETRICAL THROUGH BOL' TELEPHONE TER TERRAZZO **TONGUE & GROOVE** THICK TOC TOP OF CONCRETE TOF TOP OF FOOTING ION COEFFICIENT TOP OF JOIST TOP TOP OF PIER TOS TOP OF STEEL TOW TOP OF WALL SHED-CONTRACTOR INSTALLED TOP OF PAVEMENT TYPICAL UNIFORM BUILDING CODE UNDERCUT OPH OPPOSITE HAND UNDERGROUND PLUMBING CONTRACTOR UNIT HEATER PRECAST CONCRETE UNDERWRITERS LABORATORIES POUNDS PER CUBIC FOOT PERFORATED

PLATE / PROPERTY LINE PLAM PLASTIC LAMINATE PLBG PLUMBING PAINT / PAINTED POUNDS PER SQUARE FOOT POUNDS PER SQUARE INCH PORCELAIN TILE / PAVER TILE PVC POLYVINYL CHLORIDE QUARRY TILE

RADIUS / RISER / THERMAL RESISTANCE

QTY QUANTITY

VCT **VERT** VIF W/O

UNFIN UNFINISHED UNO UNLESS NOTED OTHERWISE UTIL UTILITY VINYL COMPOSITION TILE VERTICAL VEST VESTIBULE VERIFY IN FIELD

WITHOUT WATER CLOSET WOOD

WIND LOAD

CONSTRUCTION DOCUMENTS MAY 16, 2023

GENERAL NOTES 1. CONTRACT DOCUMENTS — ALL CONTRACTORS SHALL EXAMINE THE

AND SHALL BE INFORMED OF THE ENTIRE CONTENTS THEREOF PRIOR TO SUBMISSION OF PROPOSAL. ANY ERRORS OR AMBIGUITIES NOTED DURING SAID EXAMINATION SHALL BE IMMEDIATELY BROUGHT TO THE ATTENTION OF THE ARCHITECT, PRIOR TO THE SUBMISSION OF A BID. THE ARCHITECT WILL ISSUE AN ADDENDUM OF INTERPRETATION OF THE CITED ERROR OR

NO SUBSEQUENT CLAIM FOR EXTRA WORK WILL BE ALLOWED ON ACCOUNT OF CLAIMED MISUNDERSTANDING OF THE MEANING OR INTENT OF THE CONTRACT WHERE REMOVAL OF EXISTING CONSTRUCTION RESULTS IN DEPRESSIONS DOCUMENTS OF ANY PORTION THEREOF IF THE ITEM OCCASIONING THE CLAIM APPEARED IN, OR WAS INFERABLE FROM, SAID CONTRACT DOCUMENTS AS FURNISHED FOR BIDDING. CONTRACTORS PROPOSE TO PROVIDE ALL REQUIRED MATERIALS, LABOR, AND EQUIPMENT NECESSARY TO COMPLETE

2. CODES — ALL WORK IS TO BE PERFORMED IN STRICT COMPLIANCE WITH THE ACCORDANCE TO LOCAL RESTRICTIONS AND CONDITIONS. CONTRACTORS REQUIREMENTS OF ALL GOVERNING CODES AND ORDINANCES, INCLUDING BUT ARE TO HAVE A COPY OF SAID REQUIREMENTS AND CONDITIONS AVAILABLE NOT LIMITED TO THE 2020 BUILDING CODES OF NEW YORK STATE, ICC/ANSI 117.1-2017, OSHA REGULATIONS, AND ALL AGENCIES HAVING JURISDICTION OF

AND COMPLIANCE WITH ALL (OSHA) RELATED SAFETY REGULATIONS ARE THE SOLE RESPONSIBILITY OF THE CONTRACTORS AND THEIR SUBCONTRACTORS. THE FOLLOWING SHALL BE MAINTAINED AND/OR PROVIDED IN COMPLIANCE

3.SAFETY — IMPLEMENTING JOB SITE SAFETY CONSTRUCTION PROCEDURES

WITH CURRENT OSHA STANDARDS IN ADDITION TO ALL OTHER GOVERNING CODES AND ORDINANCES: ADEQUATE EXITS AND UNOBSTRUCTED ACCESS TO SUCH

SHALL BE MAINTAINED VISIBLE EXIT SIGNAGE SHALL BE PROVIDED OR MAINTAINED

FIRE PROTECTION PROGRAM AS WELL AS EQUIPMENT SHALL BE PROVIDED BY CONTRACTOR ACCESS TO A SUFFICIENT WATER SUPPLY SHALL BE AVAILABLE UPON ACCUMULATION OF COMBUSTIBLE

FIRE EXTINGUISHING DEVICES AND EQUIPMENT OF PROPER RATING, STANDARD, AND LOCATION

SERVICE OF FIRE RESPONSE SYSTEMS SHALL BE MAINTAINED AND CHECKED DAILY TO INSURE THAT PROTECTION IS IN SERVICE. INSIDES OF ALL ELECTRICAL AND TELEPHONE ROOMS.

4. MEANS AND METHODS — THE MEANS AND METHODS OF CONSTRUCTION ARE BUT NOT LIMITED TO MILLWORK, CASEWORK, AND COUNTERTOPS. SOLELY THE RESPONSIBILITY OF THE CONTRACTORS AND THEIR SUBCONTRACTORS. ALL CONTRACTORS ARE RESPONSIBILE TO DETERMINE ALLOWABLE CONSTRUCTION LOADS AND TO PROVIDE PROPER DESIGN AND CONSTRUCTION OF FORMWORK, STAGING, BRACING, SHEETING AND SHORING, RESHORING, ETC.—THIS INCLUDES THAT REQUIRED FOR THE CONTRACTOR VEHICLES, FORKLIFTS, MOBILE CRANES, MATERIALS STORAGE, ETC.

5. COORDINATION — ALL CONTRACTORS AND THEIR SUBCONTRACTORS ARE RESPONSIBLE FOR THE THOROUGH COORDINATION OF THE WORK WITH EACH OTHER. OBTAIN ALL NECESSARY INFORMATION REQUIRED FOR A WELL-COORDINATED INSTALLATION OF THE WORK. NO CLAIMS FOR ADDITIONAL

WORK WILL BE ACCEPTED FOR WORK RELATED TO SUCH COORDINATION.

EMPTIED IN A TIMELY MANNER.

IMPEDE THE PERFORMANCE OF ANY INSTALLED SYSTEM.

SKILLFULLY BY WORKERS ADEPT IN THEIR TRADES. SHOULD ANY MATERIAL OR WORKMANSHIP BE FOUND TO BE DEFECTIVE, IT SHALL BE REPLACED BY THE CONTRACTOR AT THEIR OWN EXPENSE.

ARRANGEMENTS FOR ALL REQUIRED INSPECTIONS.

OWNER PRIOR TO INSTALLATION.

THE PLANNED DEMOLITION

DRAWING INDEX DRAWING NOTES AND LEGENDS WALL TYPES & GENERAL CONSTRUCTION NOTES FIRST FLOOR REFLECTED CEILING PLAN **BUILDING SECTIONS** WALL SECTIONS SECTION DETAILS SECTION DETAILS FINISH INFORMATION SYMBOLS & LEGENDS UNDERSLAB PLUMBING PLAN FIRST FLOOR PLUMBING PLAN MEZZANINE PLUMBING PLAN FIRE PROTECTION PLAN

TITLE SHEET

SCHEDULES

SCHEDULES, SYMBOLS, & LEGENDS

SYMBOL LEGEND, DETAILS, & SCHEDULES

FIRST FLOOR POWER & LIGHTING PLANS

MEZZANINE POWER PLAN & PANEL SCHEDULE

MECHANICAL FLOOR PLANS

ELECTRICAL DEMOLITION PLAN

ARCHITECTURAL

PLUMBING


MECHANICAL

ELECTRICAL

M100

Project Status: CONSTRUCTION **DOCUMENTS**

Sheet Title: TITLE SHEET

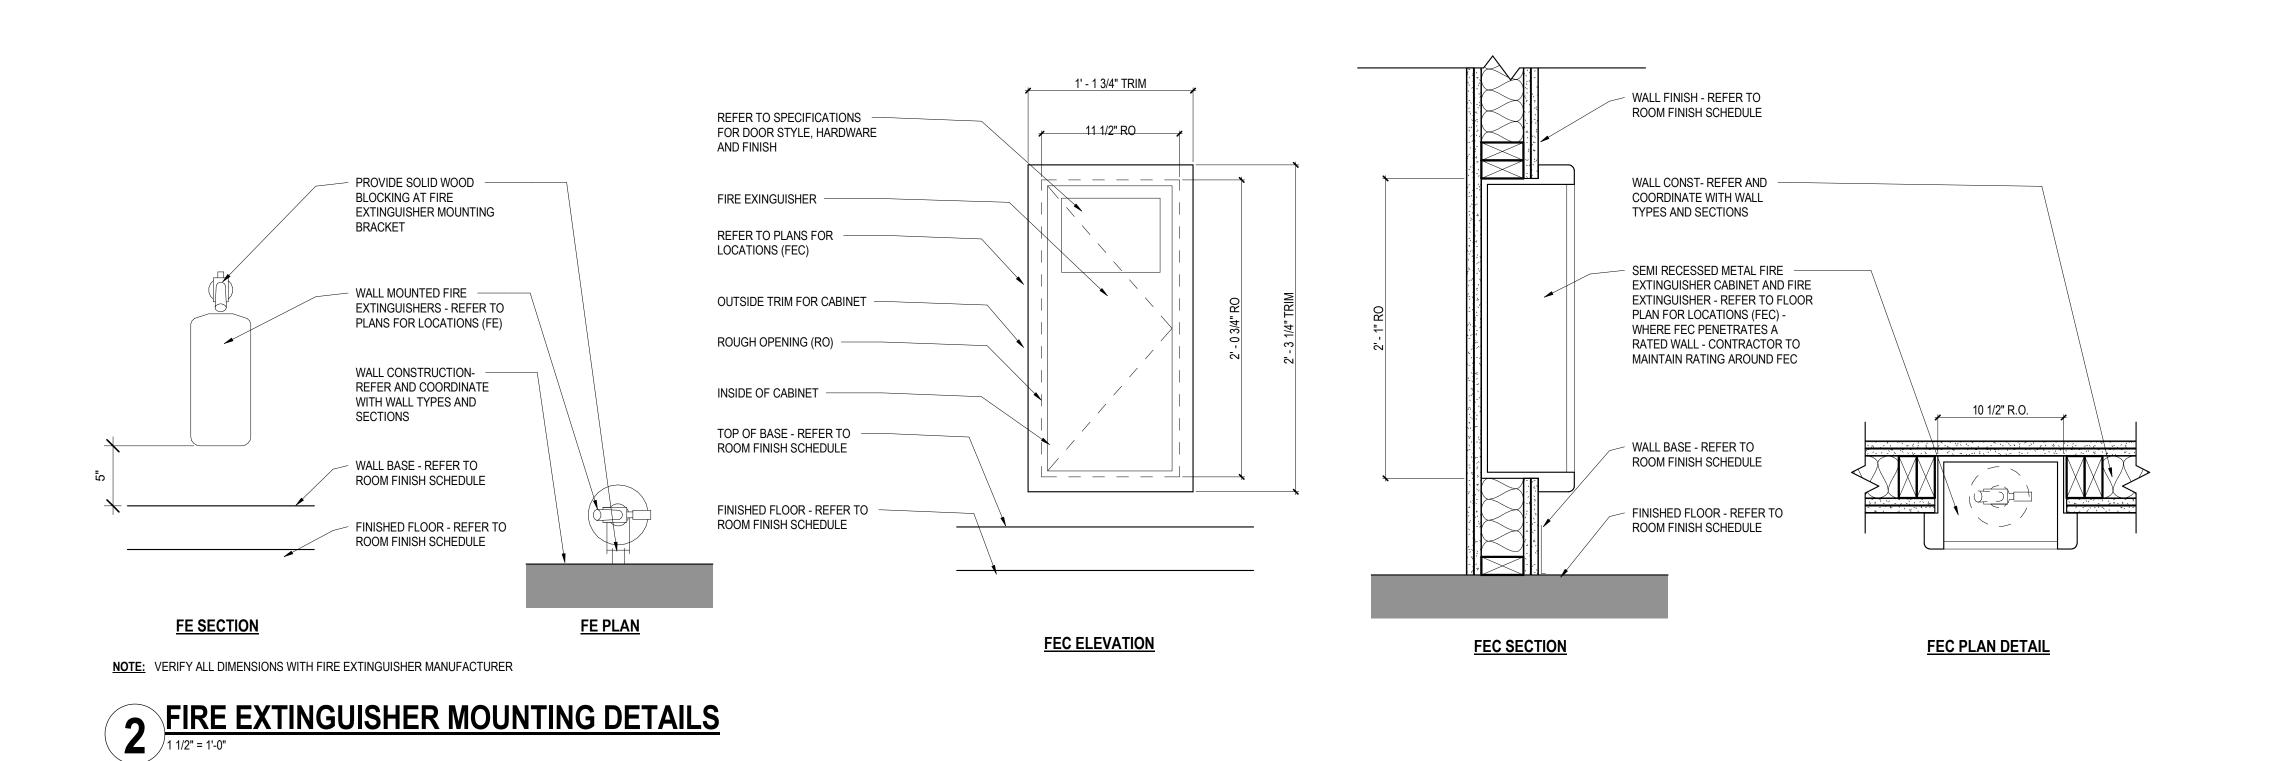

NUMBER NUMBER A NUMBER NUMBER SHEET NUMBER TRUE NORTH PROJECT NORTH STRUCTURAL GRID TAG FINISH FACE OF SURFACES ALIGN ROOM NAME ROOM TAG 10000 NUMBER 150 SF AREA 0000 DOOR TAG (P1 WALL TAG LOUVER TAG REFER TO DRAWING NOTE EXISTING PARTITION TO BE REMOVED EXISTING PARTITION NEW MASONRY PARTITION NEW METAL STUD W/ GWB PARTITION 1HR WALL ARCH - SYMBOLS LEGEND NOT TO SCALE

SYMBOL LEGEND

Client: EMPIRE STATE DEVELOPMENT

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Signature & Seal:

Project: LONGSHED INTERIOR **RENOVATIONS**

CANALSIDE Project Address:

BUFFALO, NY 14202


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CONSTRUCTION **DOCUMENTS**

Project Number:

Sheet Title: DRAWING NOTES AND LEGENDS


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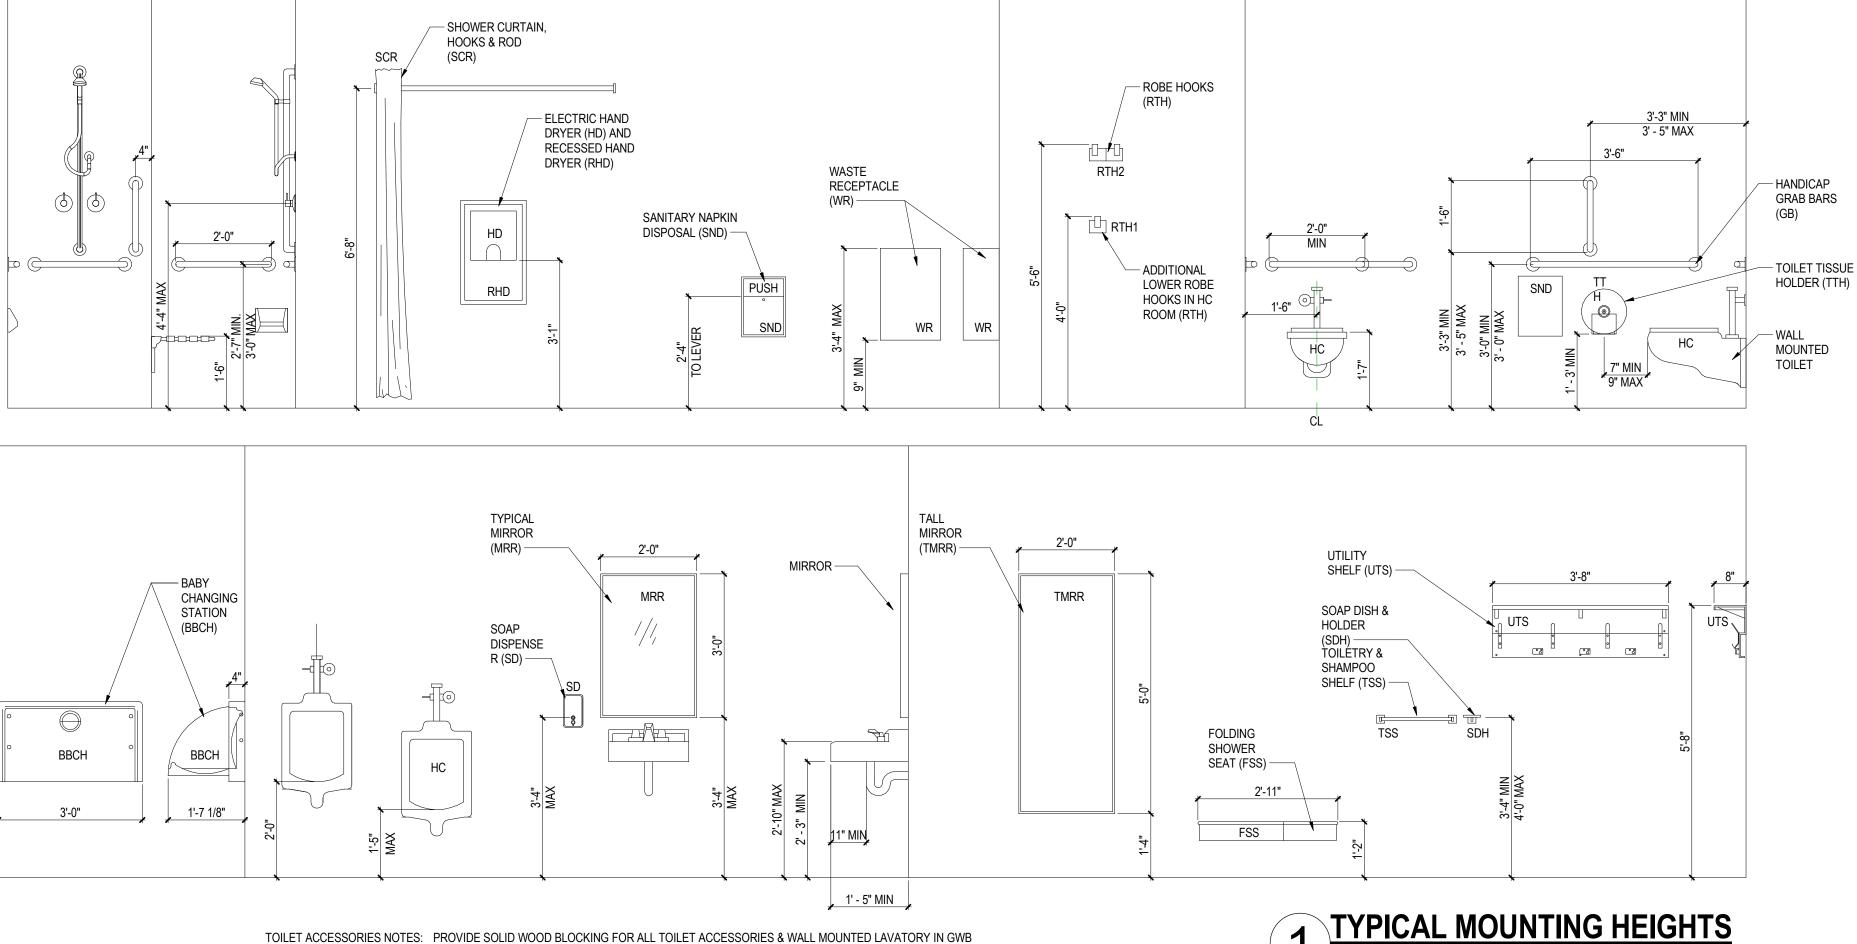



- ALL NEW ROOM SIGNAGE TO MATCH EXISTING ROOM SIGNAGE MATERIAL, COLOR, PROFILE, ETC.
- ALL TACTILE SIGNAGE FOR ROOM IDENTIFICATION LOCATED ADJACENT TO A DOOR SHALL BE MOUNTED ON THE LATCH SIDE OF THE DOOR WHERE DOUBLE DOORS EXIST, SIGNAGE SHALL BE MOUNTED TO THE RIGHT OF THE DOOR. WHERE THERE IS NO WALL SPACE AVAILABLE FOR SIGNAGE, MOUNT SIGN TO NEAREST ADJACENT WALL.
- SIGNAGE SHALL BE 60" TO THE CENTER OF THE SIGN.
- REFER TO ROOM FINISH SCHEDULE FOR LOCATIONS OF ROOM SIGNAGE
- REFER TO SIGNS SPECIFICATION SECTION 101423 MOUNTING VERTICAL HEIGHT: 60 INCHES FROM FLOOR TO CENTERLINE OF SIGN
- MOUNTING HORIZONTAL WIDTH: 10 INCHES FROM OUTSIDE FACE OF FRAME TO CENTERLINE OF SIGN
- MOUNT ON WALL ADJACENT TO THE LATCH SIDE OF THE DOOR MOUNT TO AVOID DOOR SWING/PROTRUDING OBJECTS
- ACTUAL NUMBERS TO BE COORDINATED WITH DIRECTOR'S REPRESENTATIVE BEFORE MANUFACTURING OF SIGNS

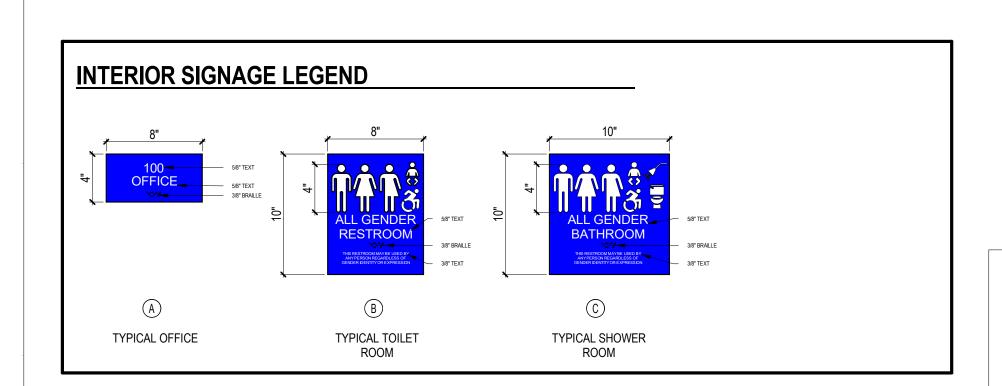





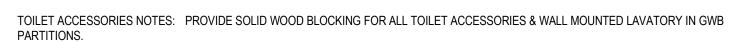

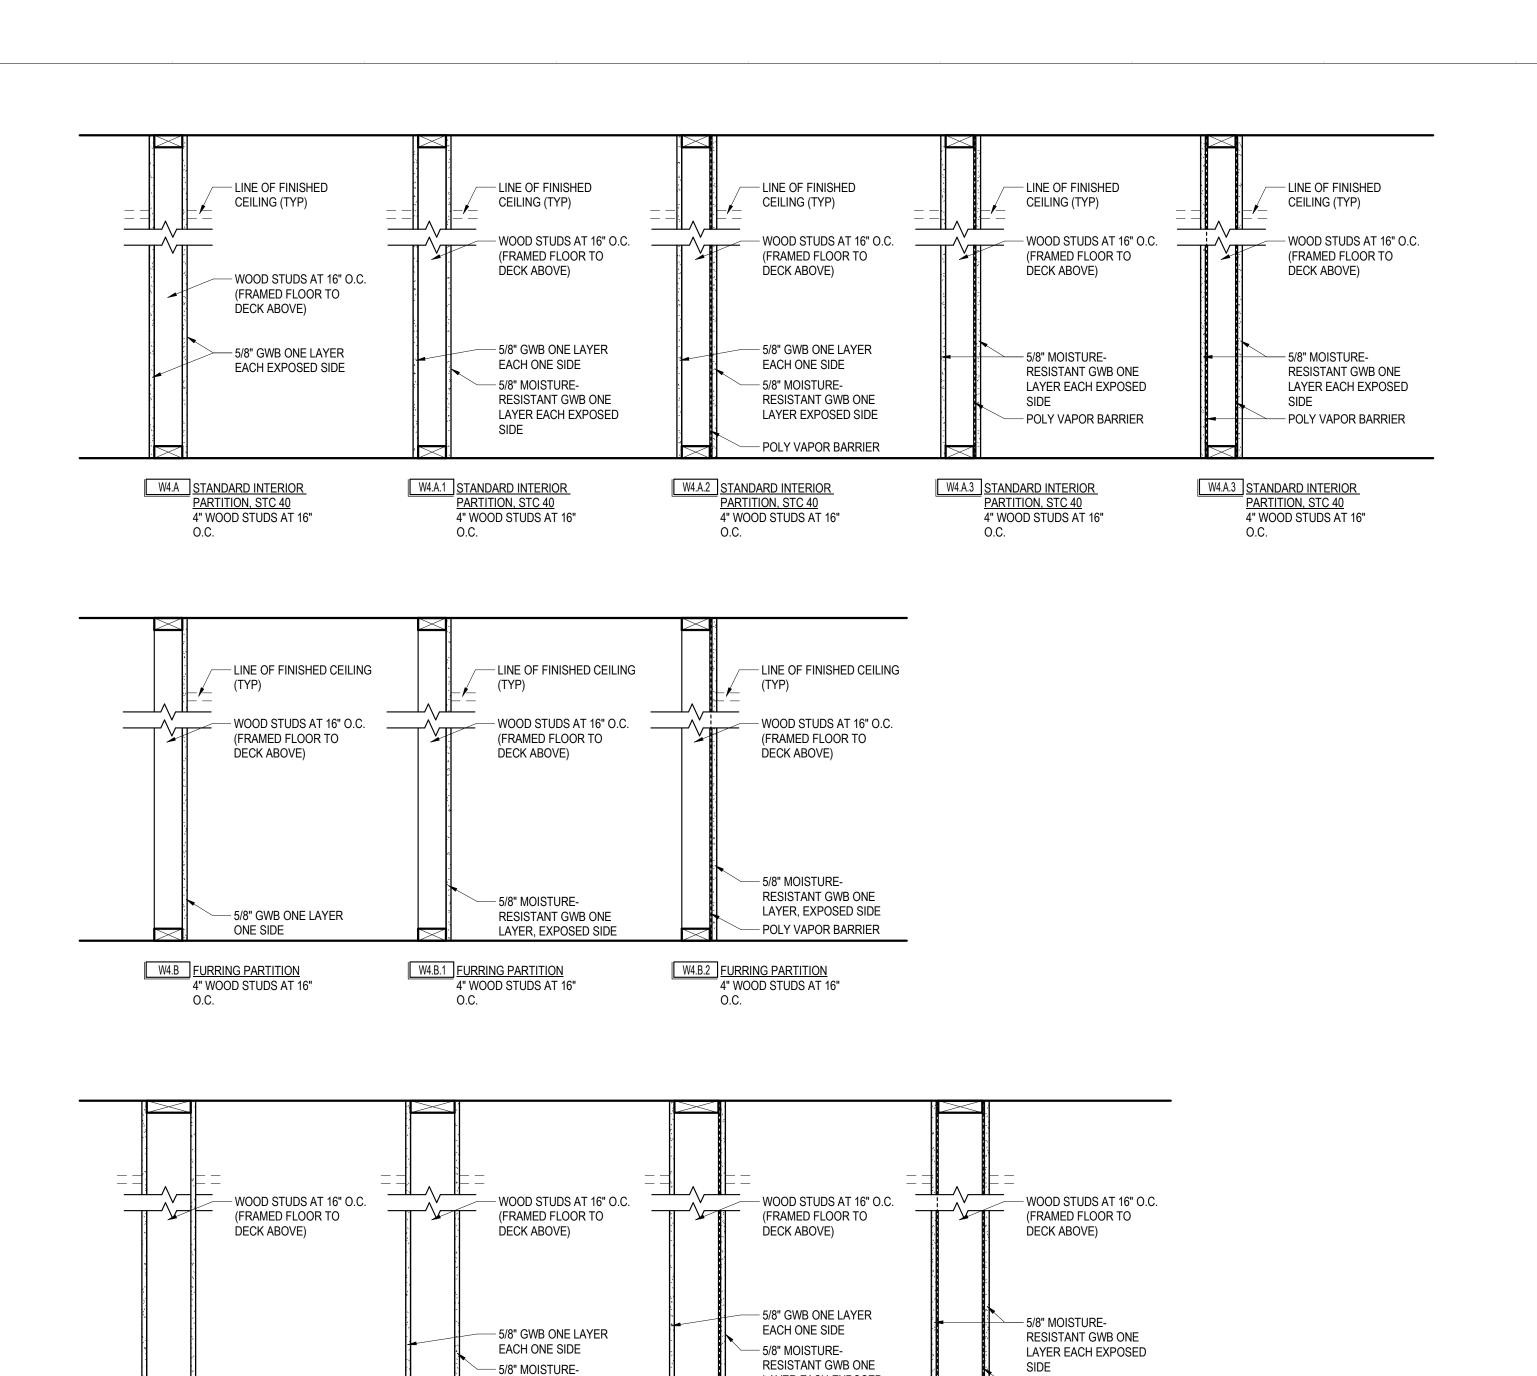

LAYER EACH EXPOSED

— POLY VAPOR BARRIER

SIDE

6" WOOD STUDS AT 16"

W6.A.2 STANDARD INTERIOR PARTITION, STC 40

— POLY VAPOR BARRIER

W6.A.3 STANDARD INTERIOR PARTITION, STC 40

6" WOOD STUDS AT 16"

RESISTANT GWB ONE

W6.A.1 STANDARD INTERIOR
PARTITION, STC 40
6" WOOD STUDS AT 16"

LAYER EACH EXPOSED

1 Wall Types

6" WOOD STUDS AT 16"

W6.A STANDARD INTERIOR PARTITION, STC 40

- 5/8" GWB ONE LAYER

EACH EXPOSED SIDE



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Client: EMPIRE STATE DEVELOPMENT

Project: LONGSHED INTERIOR RENOVATIONS

Project Address: CANALSIDE

BUFFALO, NY 14202


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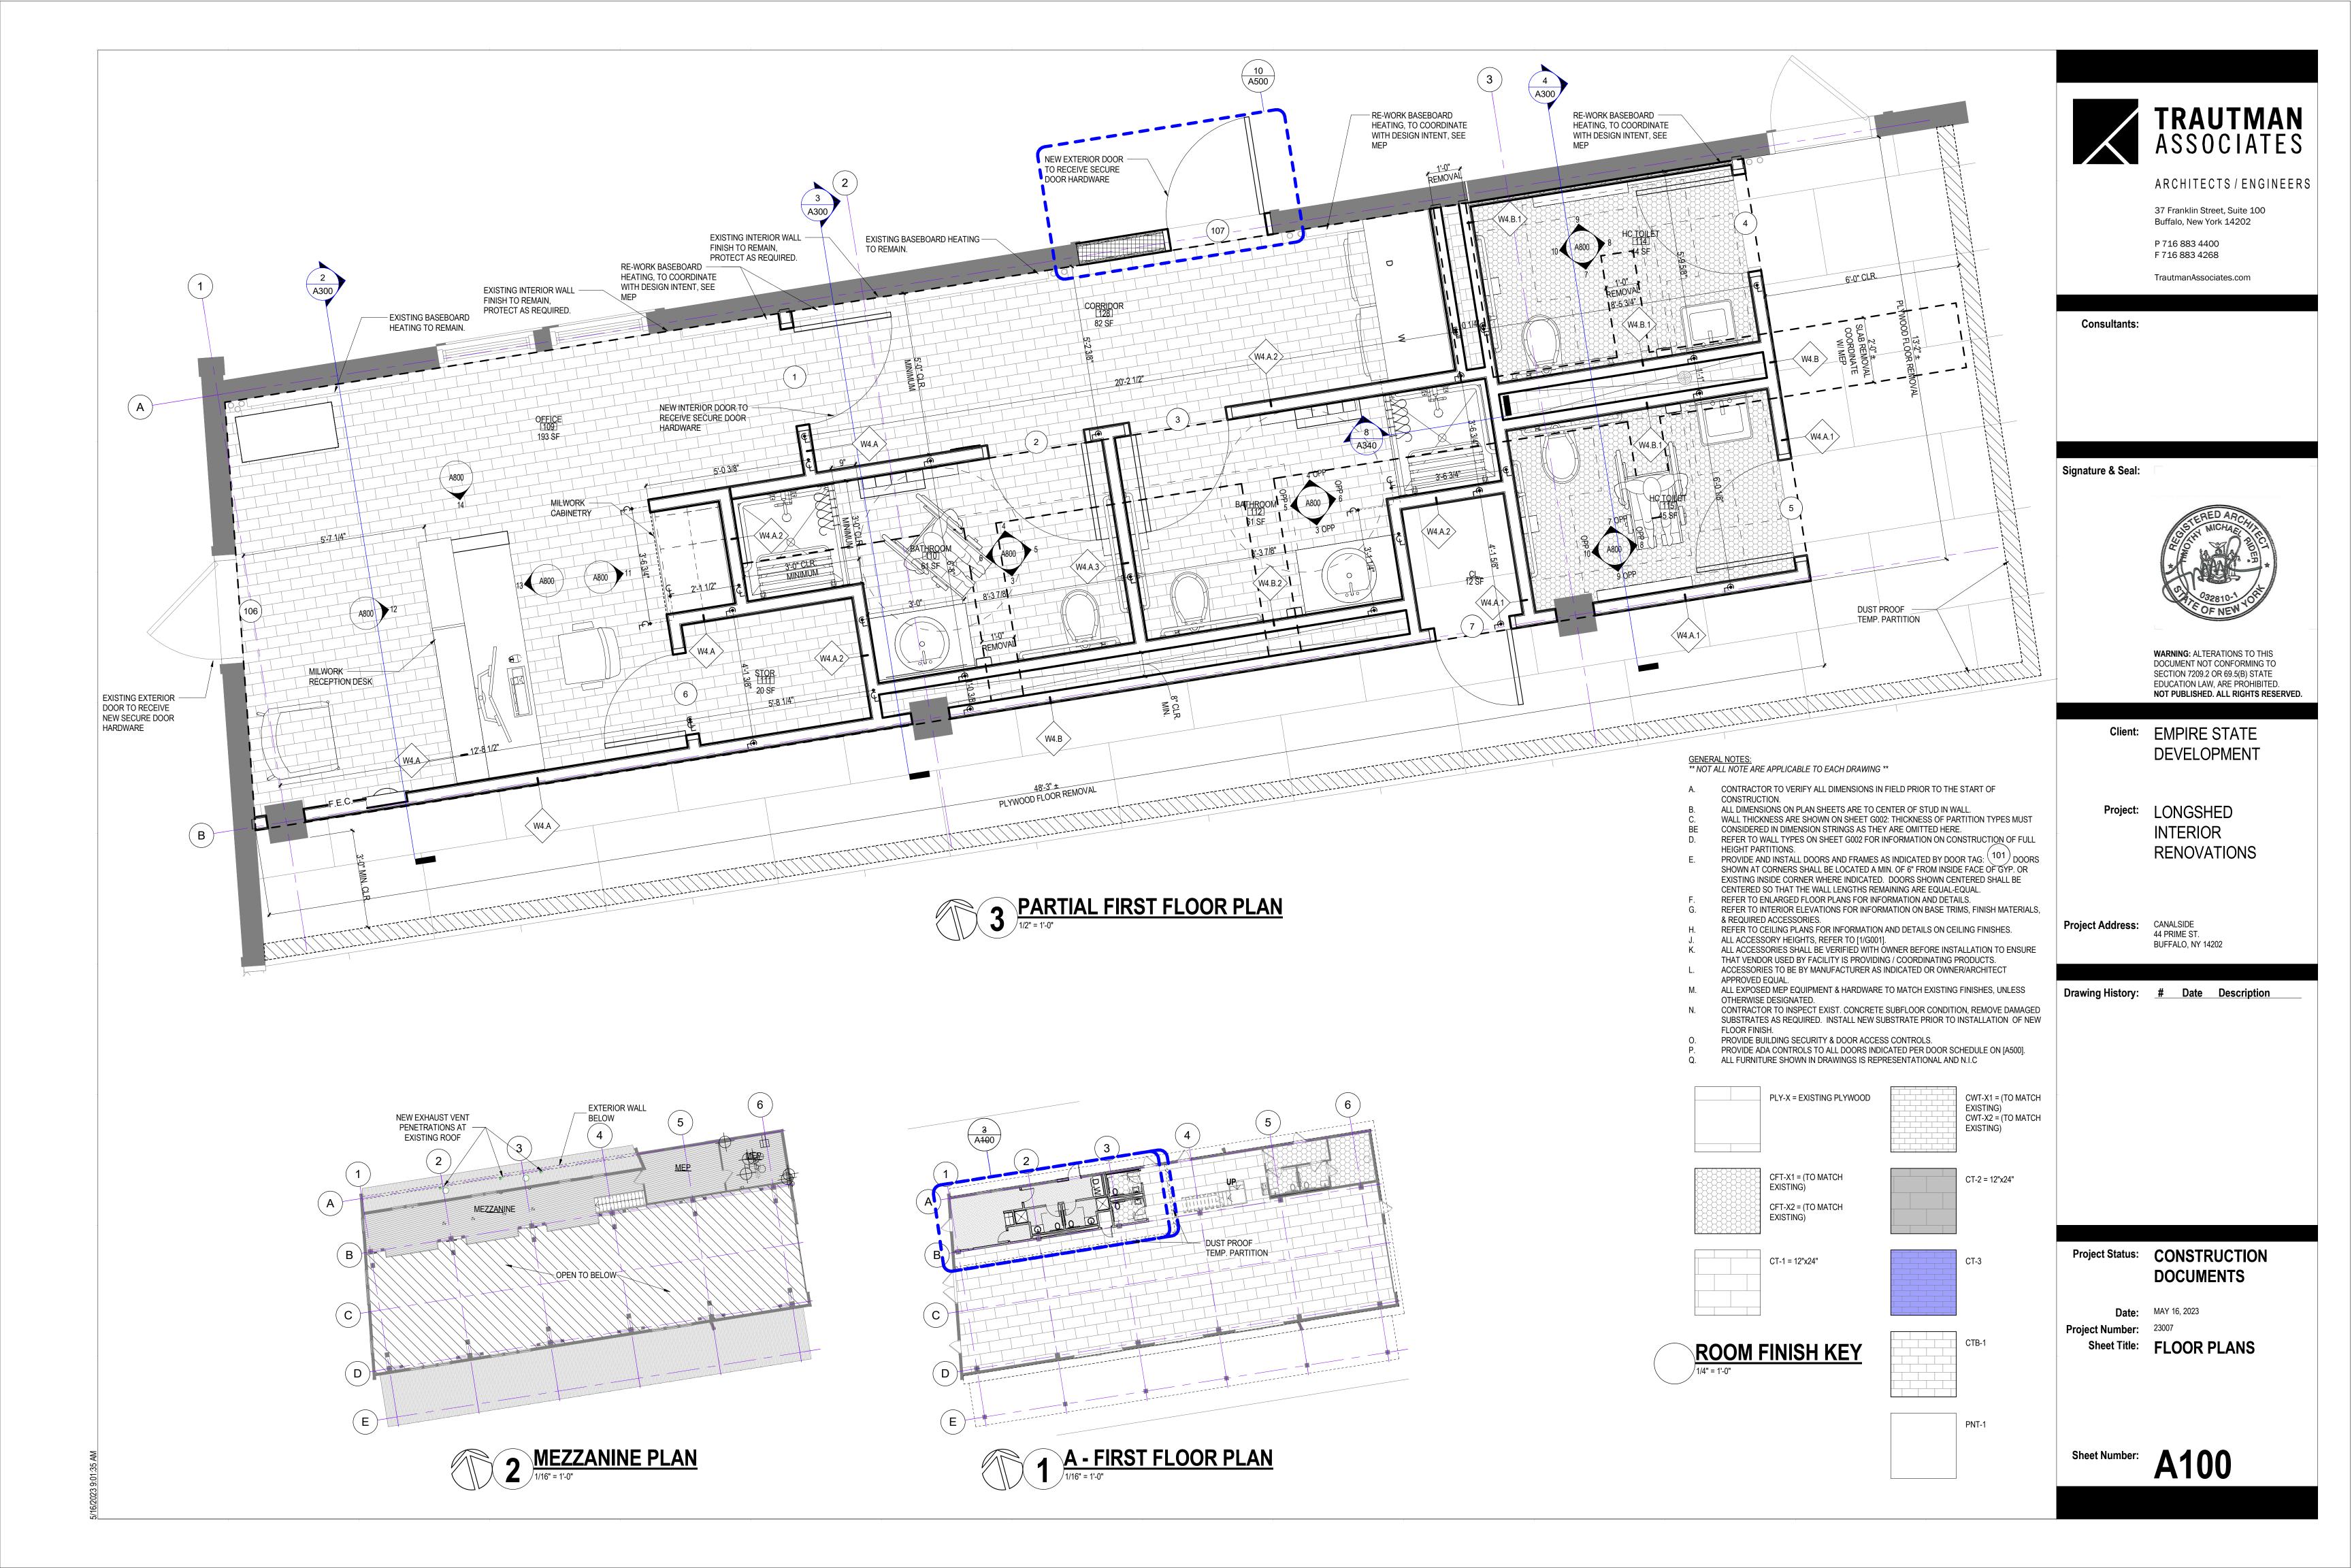
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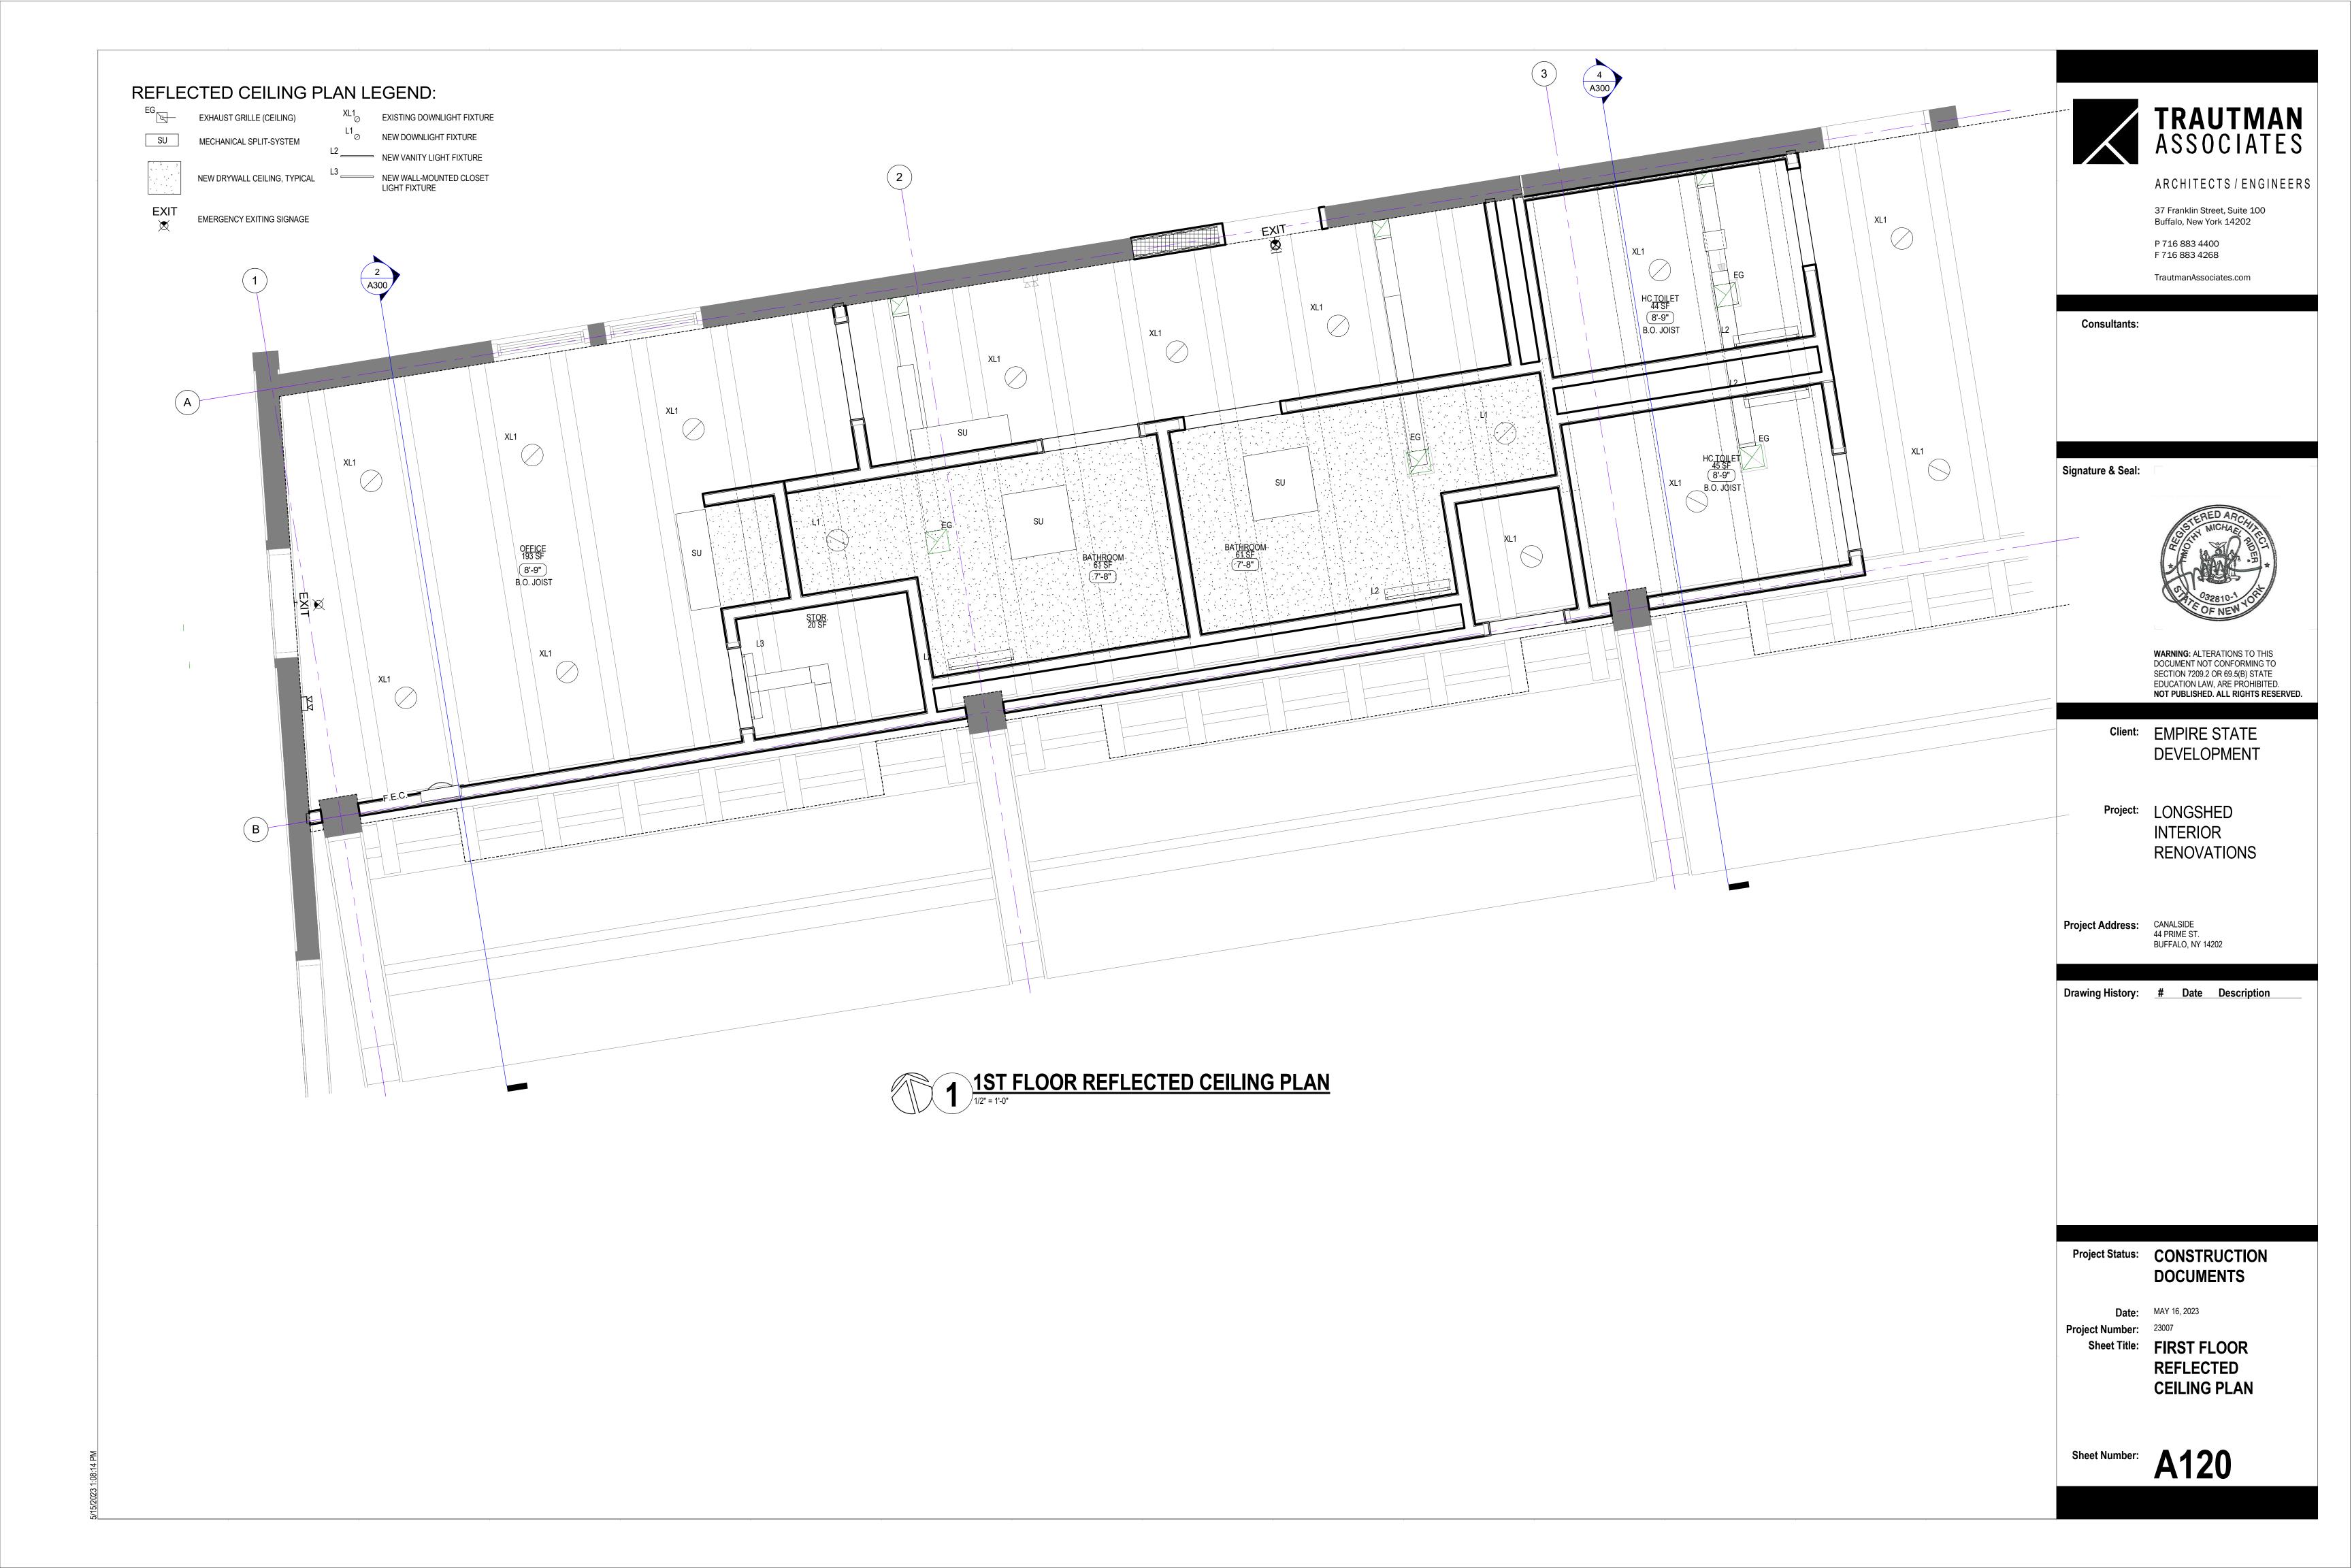
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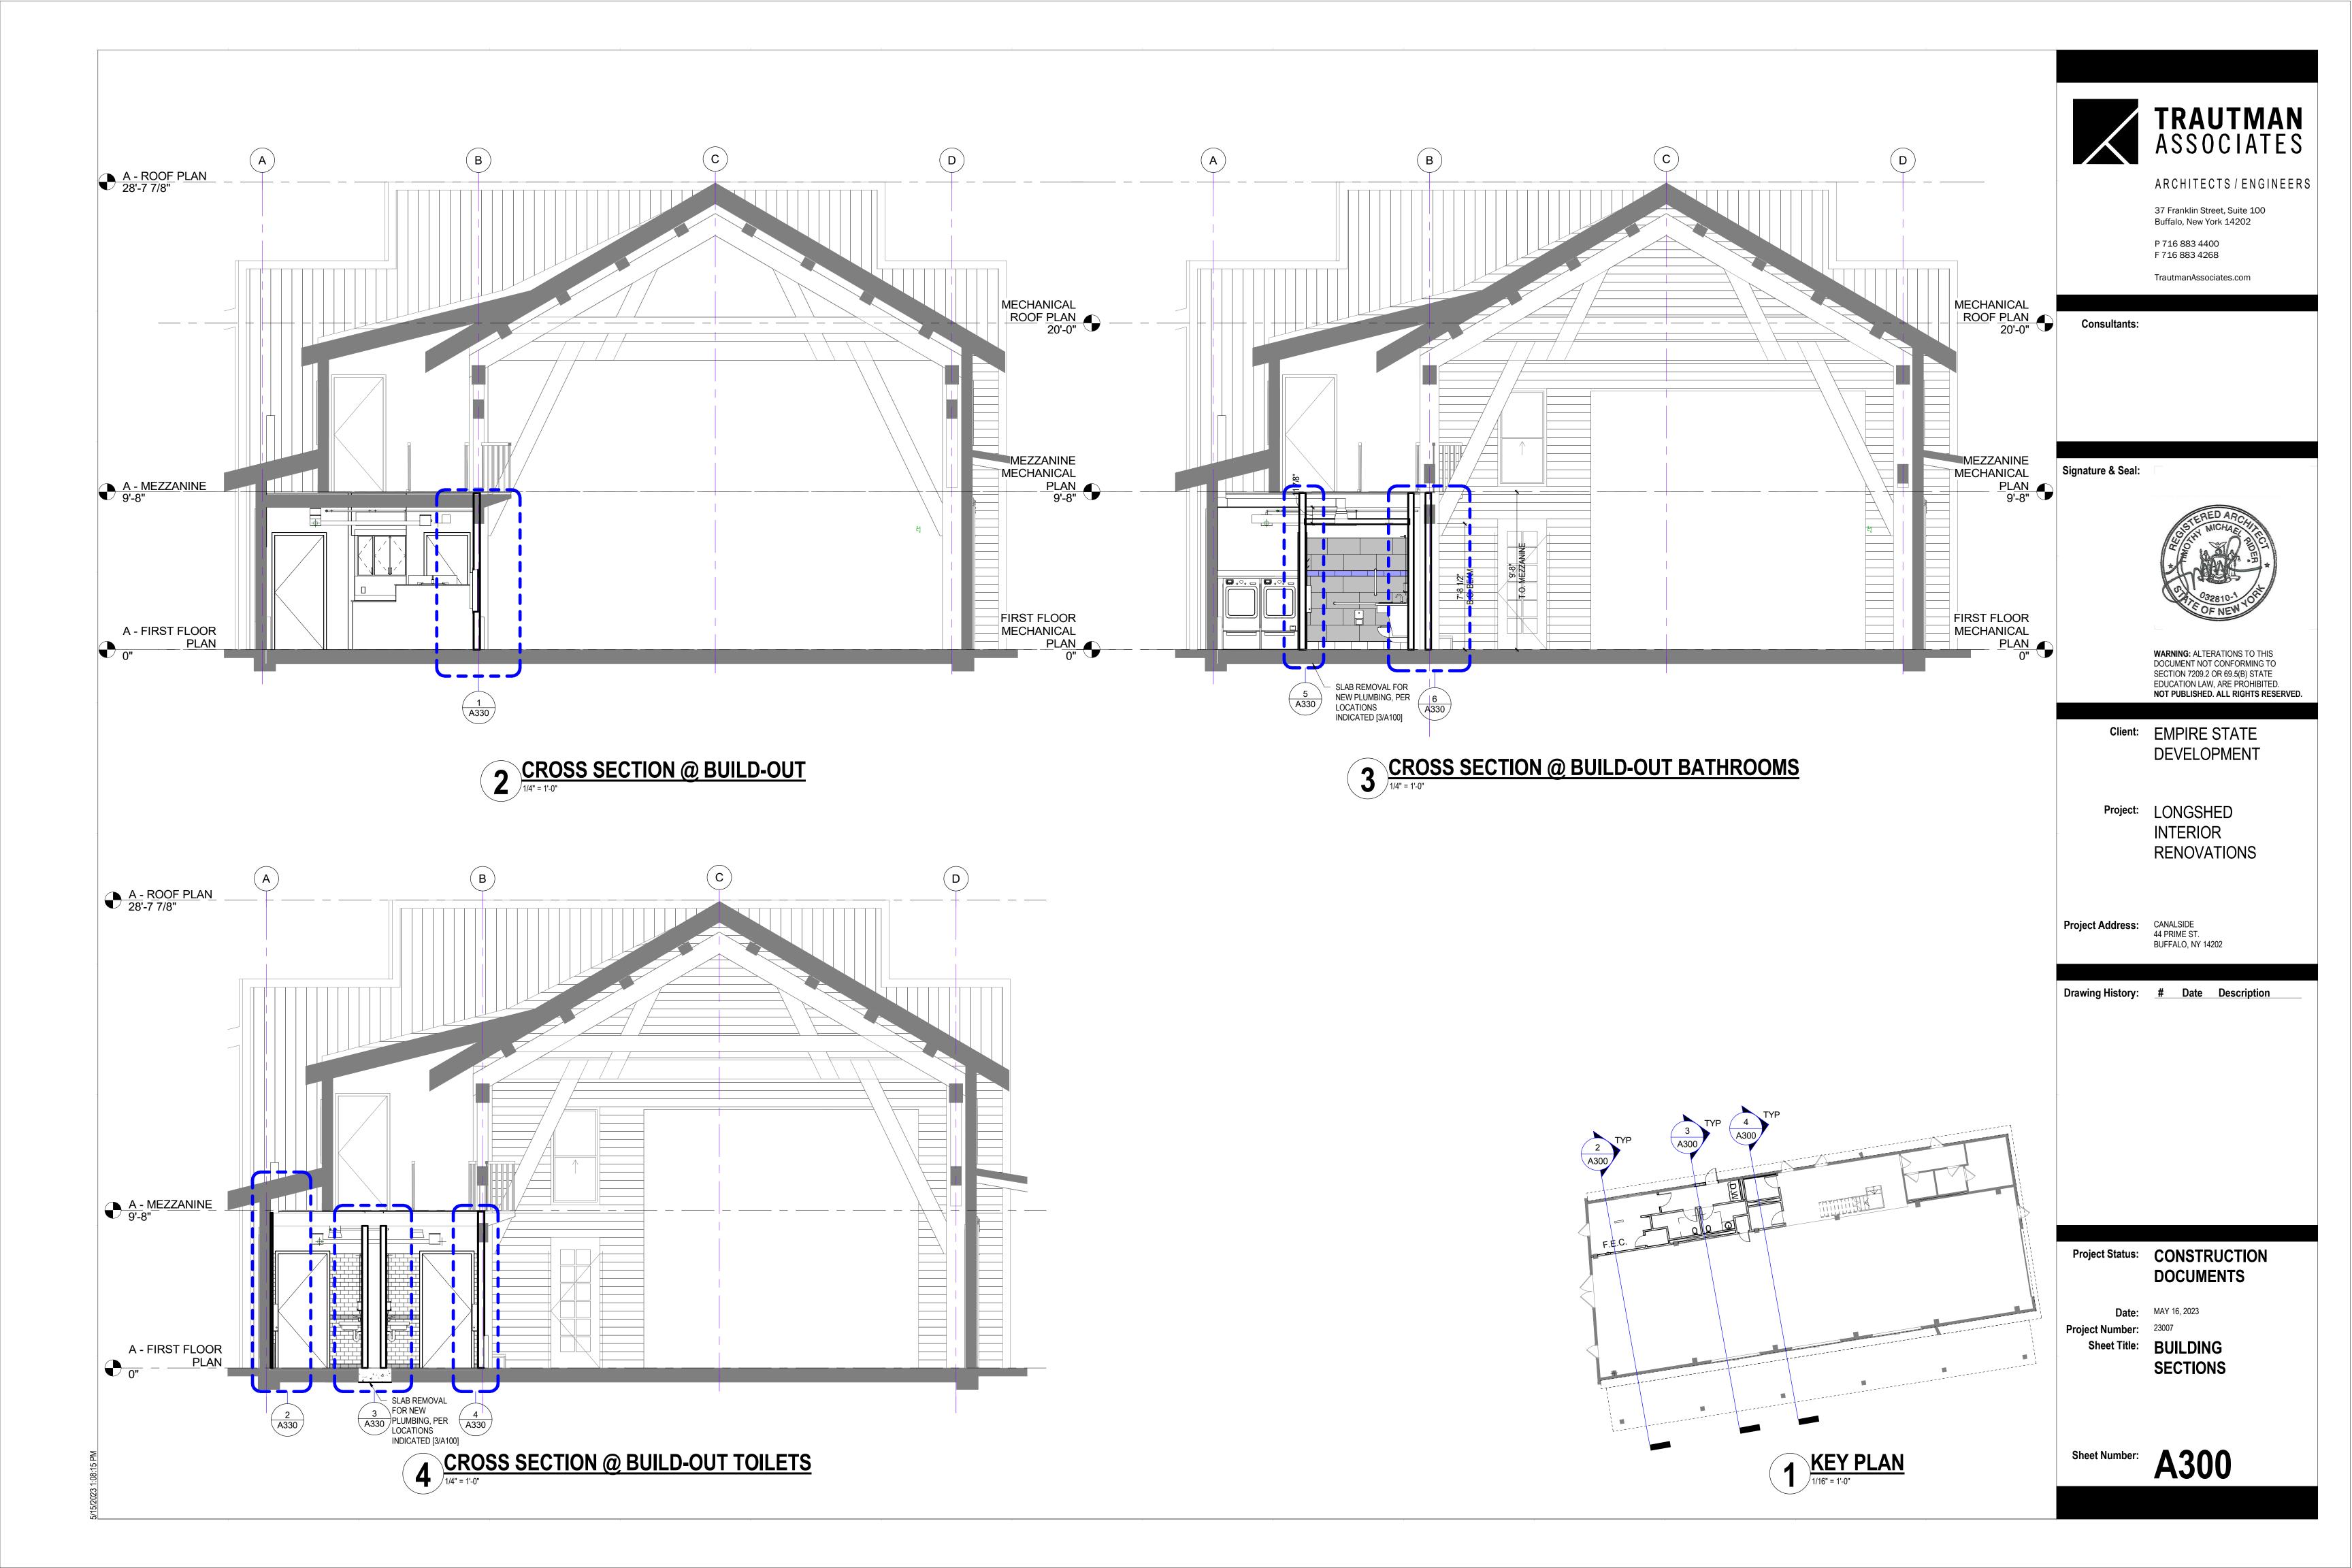
Sheet Title: WALL TYPES & **GENERAL** CONSTRUCTION **NOTES**


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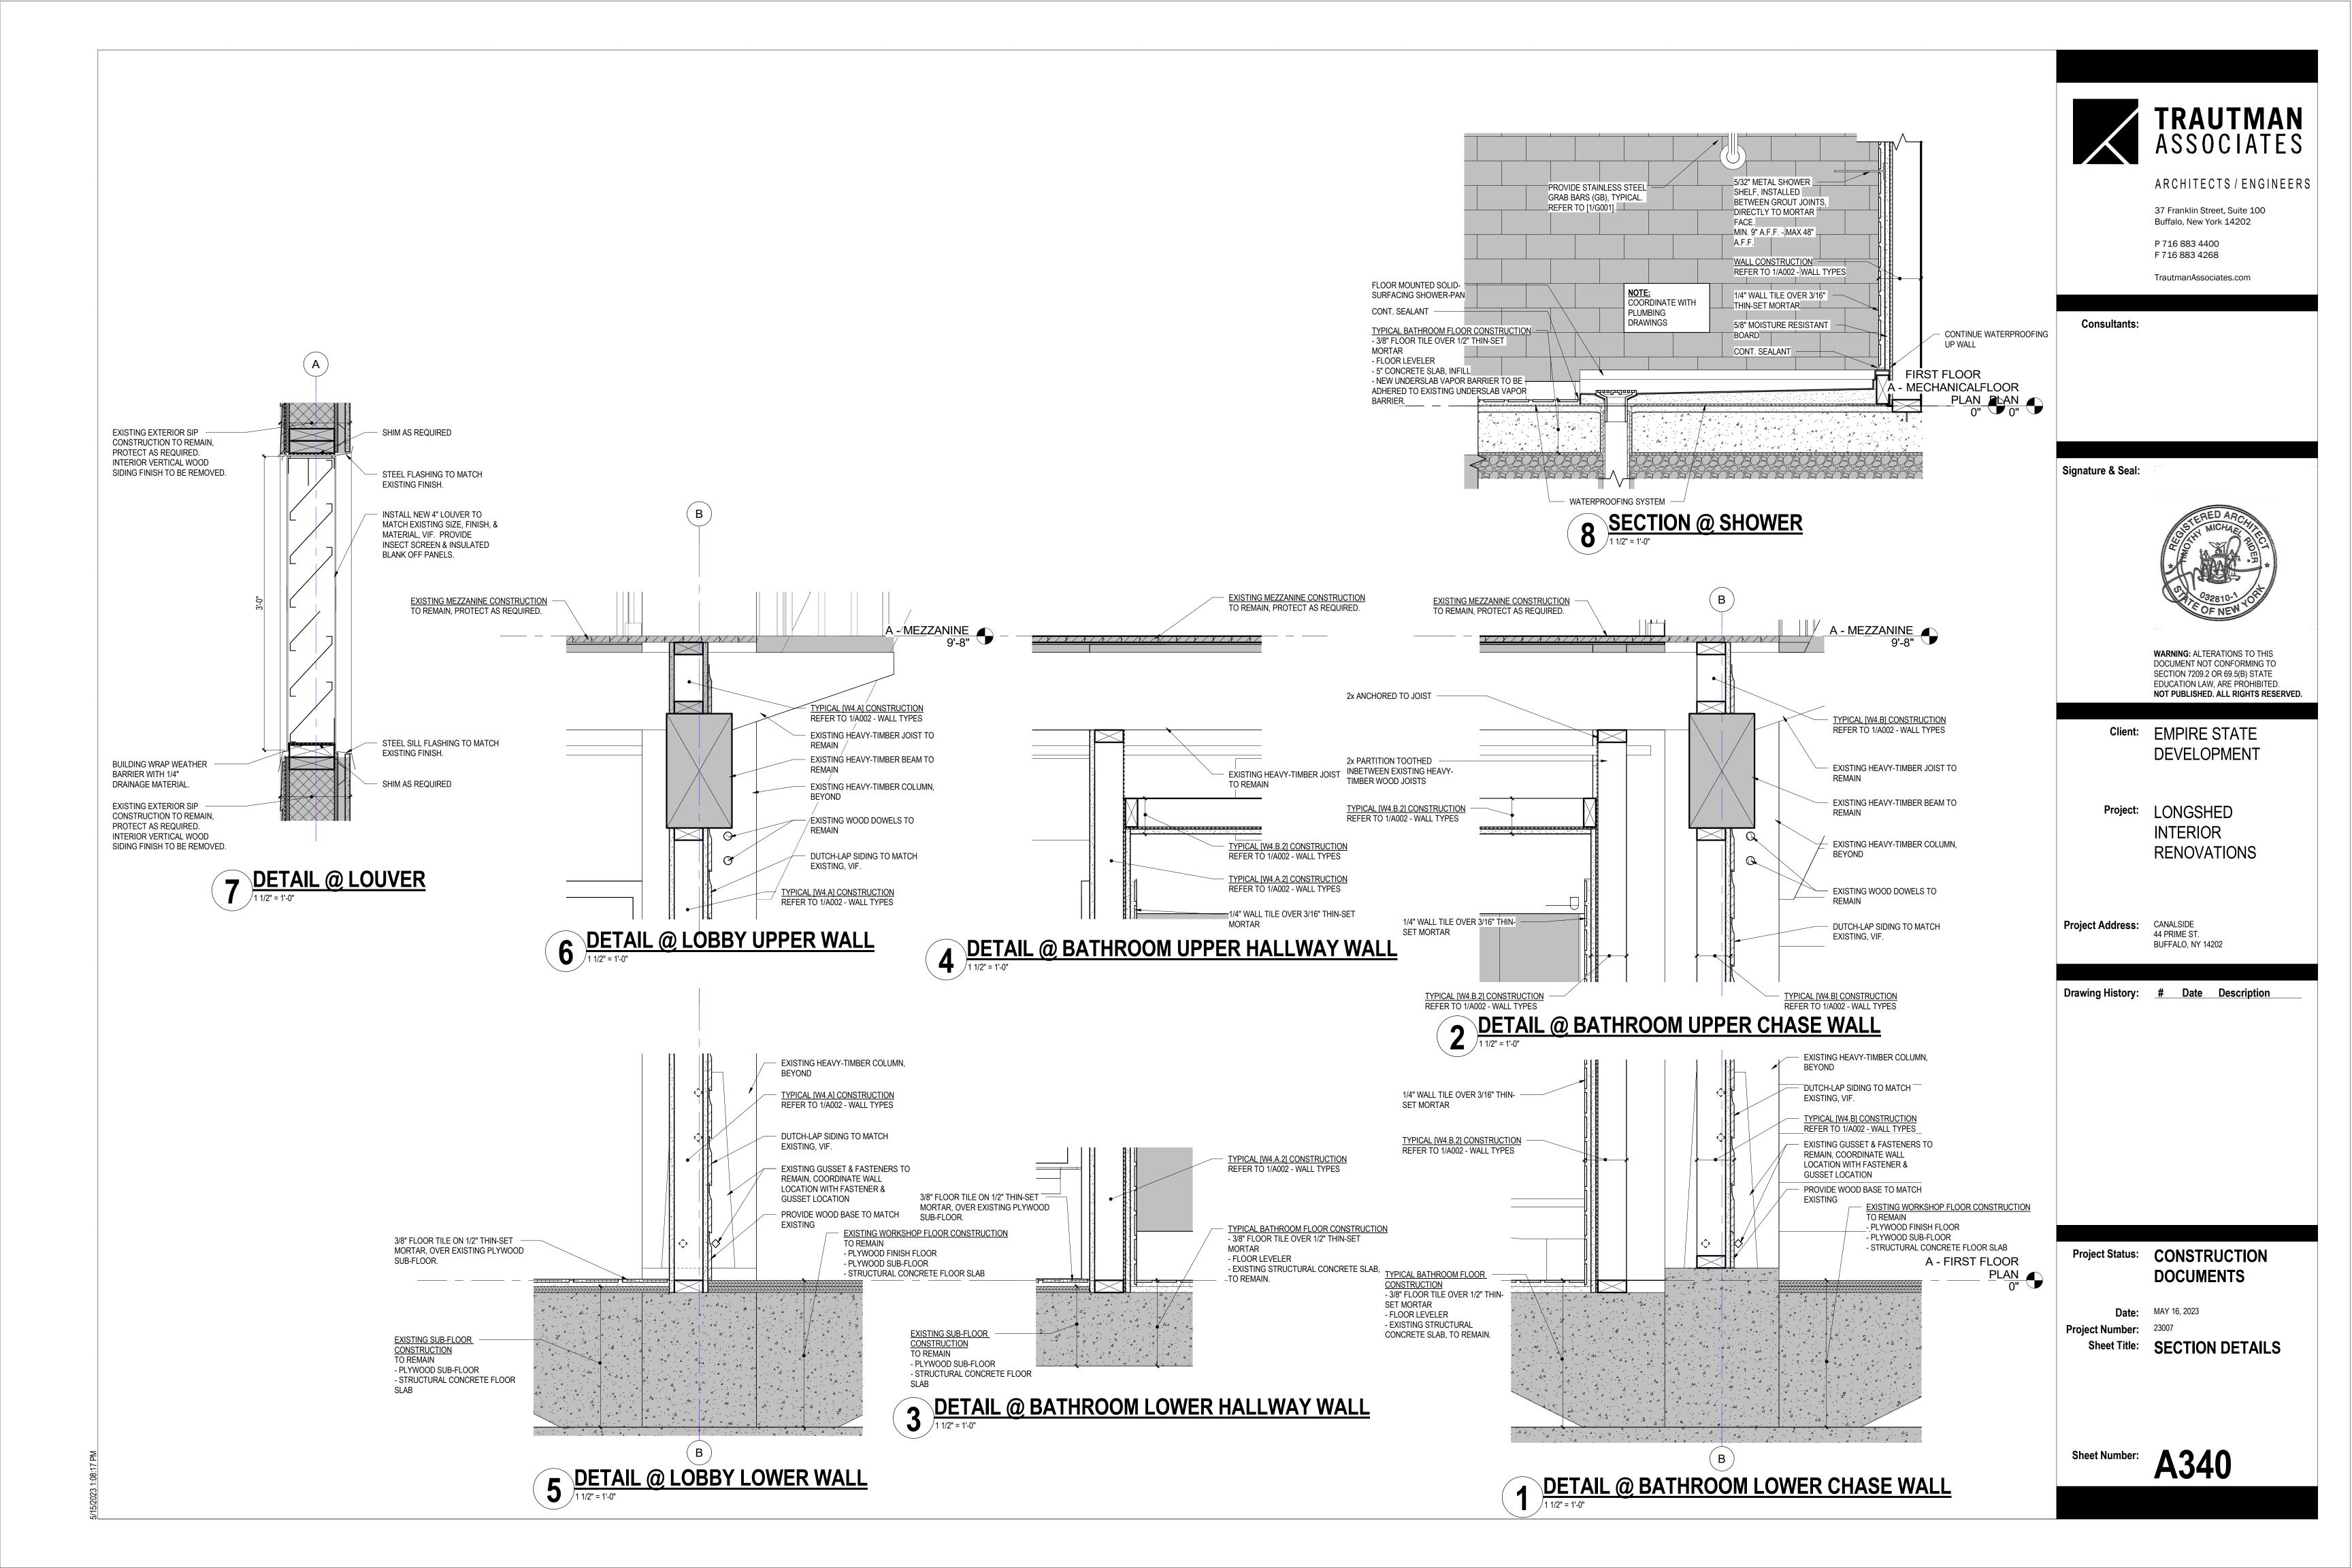







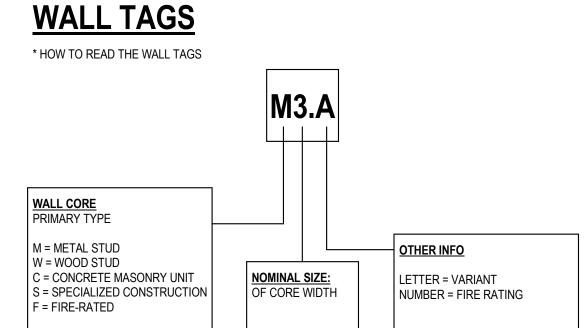

TRAUTMAN ASSOCIATES

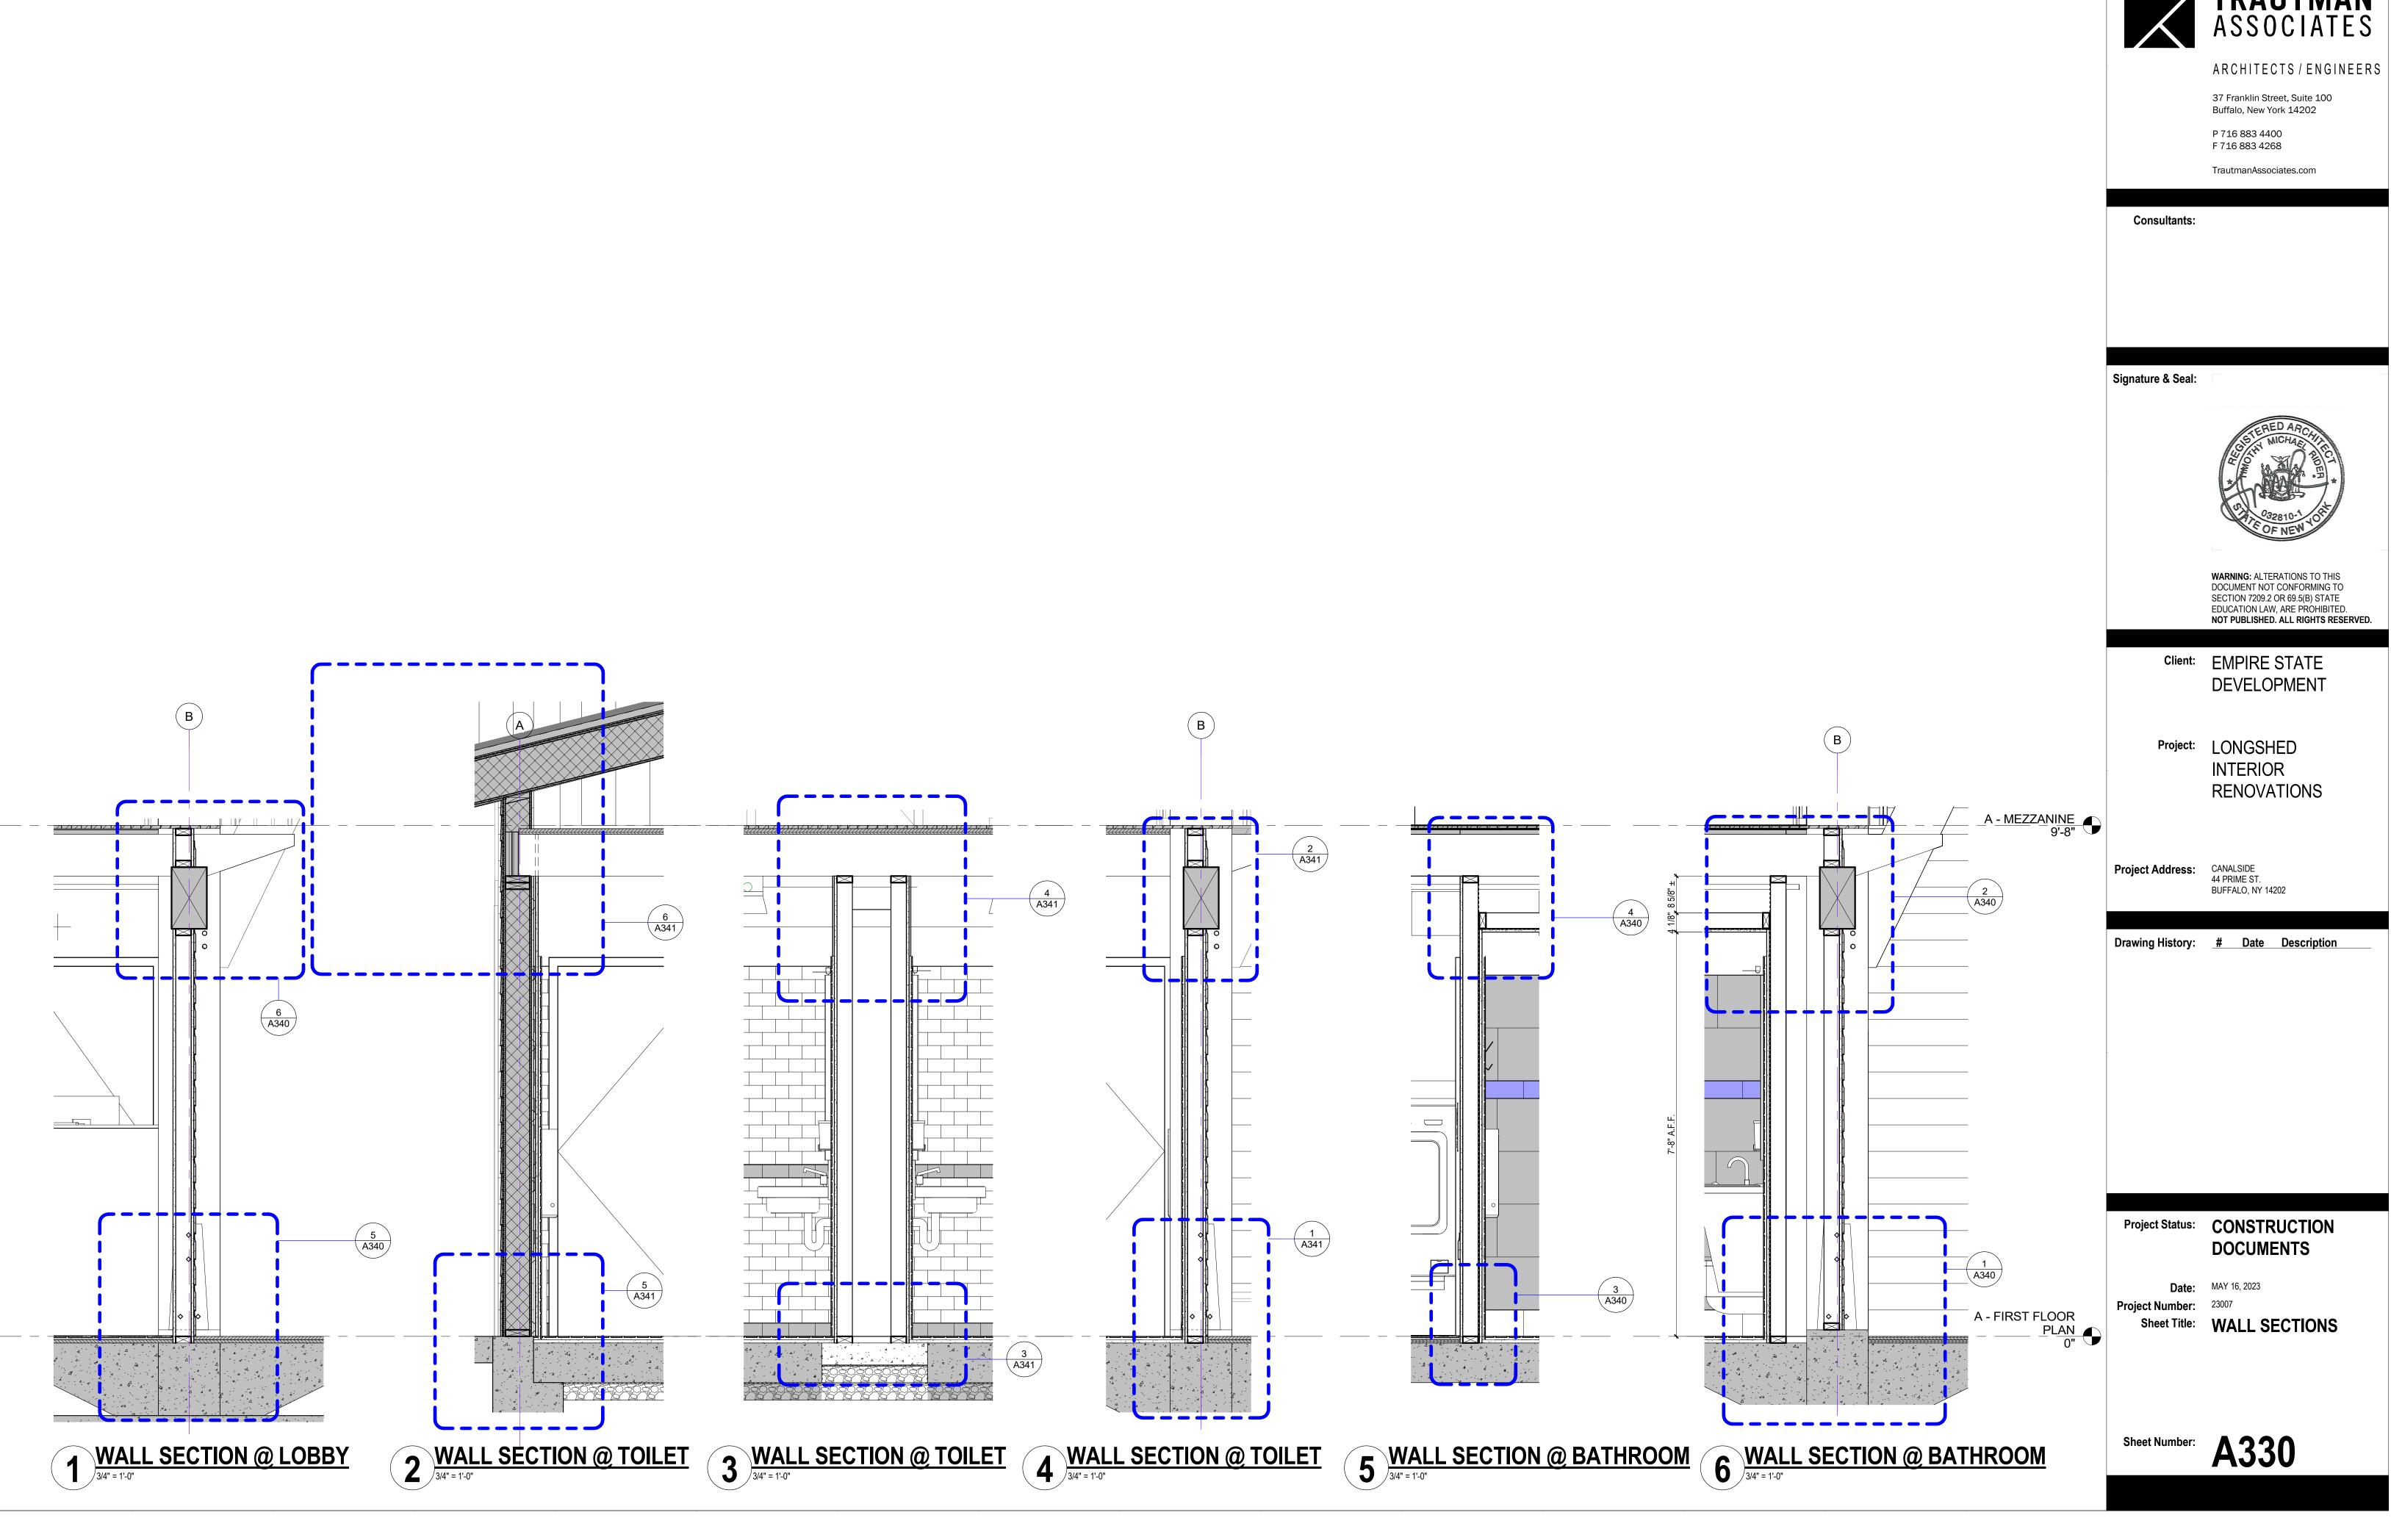

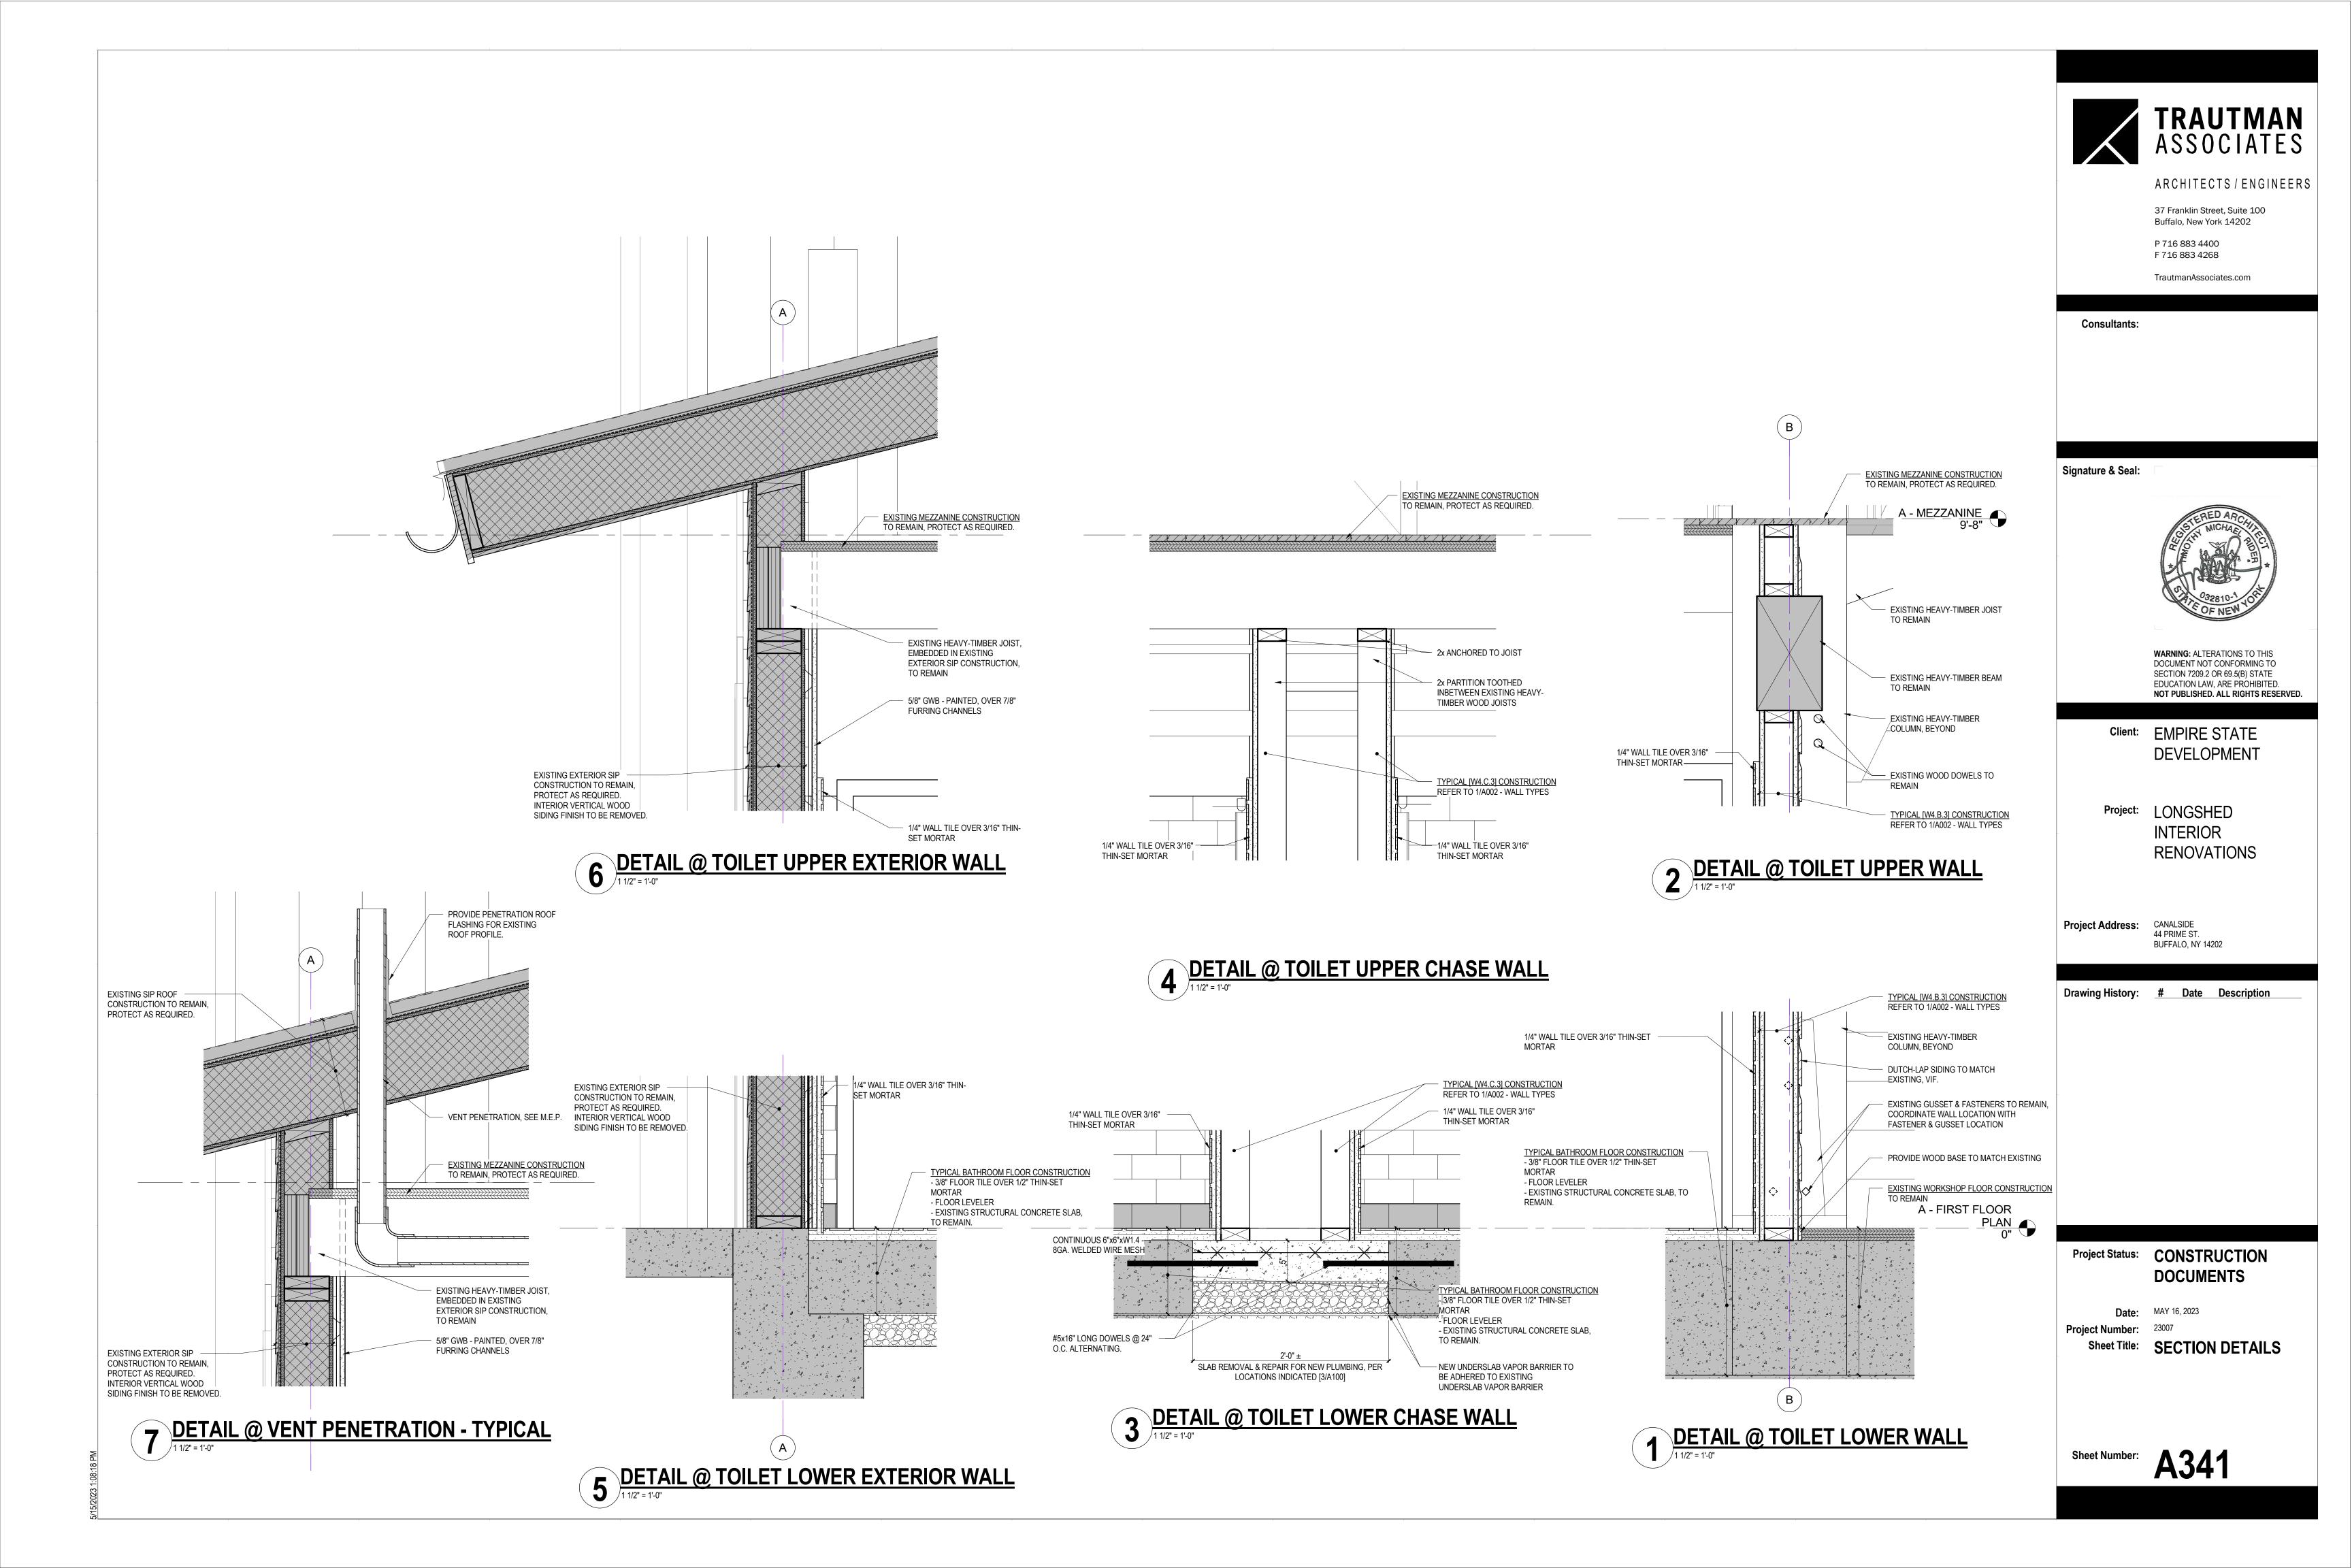

						DOC	OR SCH	DULE				
DOOR			[DOOR	F	RAME		DETA	AILS	HARDWARE	FIRE	
NO.	WIDTH	HEIGHT	TYPE	MATERIAL	TYPE	MATERIAL	HEAD	JAMB	THRESHOLD	GROUP	RATING	REMARKS
			F	146		145						
1	3'-0"	7'-0"	F	WD		WD	1	2	3	01		NEW INTERIOR DOOR TO RECEIVE CRASHBAR & SECURE ELECTRIC LATCHING HARDWARE
2	3'-0"	7'-0"	F	WD		HM.	7	8	3	02		MATCH EXIST INTERIOR DOOR SPECIES, COLOR, PROFILE, ETC.
3	3'-0"	7'-0"	F	WD		HM.	7	8	3	02		MATCH EXIST INTERIOR DOOR SPECIES, COLOR, PROFILE, ETC.
4	3'-0"	7'-0"	F	WD		WD	1	2	3	02		MATCH EXIST INTERIOR DOOR SPECIES, COLOR, PROFILE, ETC.
5	3'-0"	7'-0"	F	WD		WD	1	2	3	02		MATCH EXIST INTERIOR DOOR SPECIES, COLOR, PROFILE, ETC.
6	2'-6"	7'-0"	F	WD		HM.	7	8	3	03		MATCH EXIST INTERIOR DOOR SPECIES, COLOR, PROFILE, ETC.
7	2'-4"	7'-0"	F	WD		WD	1	2	3	03		MATCH EXIST INTERIOR DOOR SPECIES, COLOR, PROFILE, ETC.
106	3'-0"	8'-0"	FG	EXIST.	EXIST.	EXIST.	4	5	6			
107	3'-0"	8'-0"	G	WD		WD	4	5	6	04		NEW EXTERIOR DOOR TO RECEIVE CRASHBAR & SECURE ELECTRIC LATCHING HARDWARE

7" 10 1/2" 7"

INSULATION - REFER TO

WALL SHEATHING, REFER

WALL FINISH, REFER TO

CONT. 2x WOOD BLOCKING

WOOD DOOR FRAME, STAIN -

1/4" SPACE FOR WOOD

ANCHOR TO WOOD

LINE OF JAMB BEYOND

ADD DOOR (SEE DOOR

WOOD DOOR FRAME, STAIN - ANCHOR TO WOOD

ADD DOOR (SEE DOOR

BLOCKING.

SCHEDULE)

1/4" SPACE FOR WOOD

WALL FINISH, REFER TO

ROOM FINISH SCHEDULE

LINE OF JAMB DEYOND

ADD DOOR (SEE DOOR

ALUM. THRESHOLD

FLOOR FINISH - REFER TO

ROOM FINISH SCHEDULE

SCHEDULE)

BLOCKING.

WOOD DOOR HEAD - TYPICAL

WALL FINISH, REFER TO

EXTERIOR SIDING TO REMAIN, PROTECT AS

REQUIRED.

FINISH SCHEDULE

TO WALL TYPE

FINISH SCHEDULE

DOOR TYPES

REFER TO WALL TYPE

WOOD DOOR JAMB - TYPICAL

3" = 1'-0"

3 DOOR THRESHOLD - TYPICAL
3" = 1'-0"

INSULATION - REFER TO

WALL TYPE

WALL SHEATHING, REFER





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Client: EMPIRE STATE

DEVELOPMENT

Project: LONGSHED **INTERIOR RENOVATIONS**

CANALSIDE **Project Address:** 44 PRIME ST.


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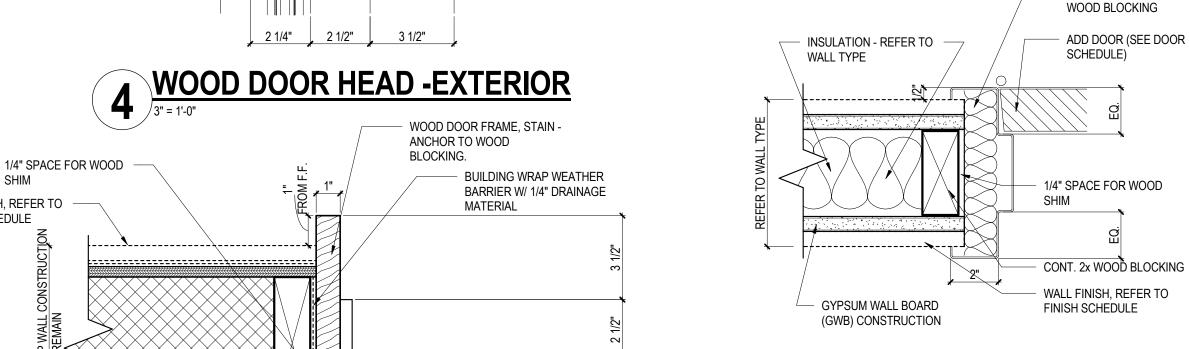
BUFFALO, NY 14202

Project Status: CONSTRUCTION

Sheet Title: SCHEDULES

A500




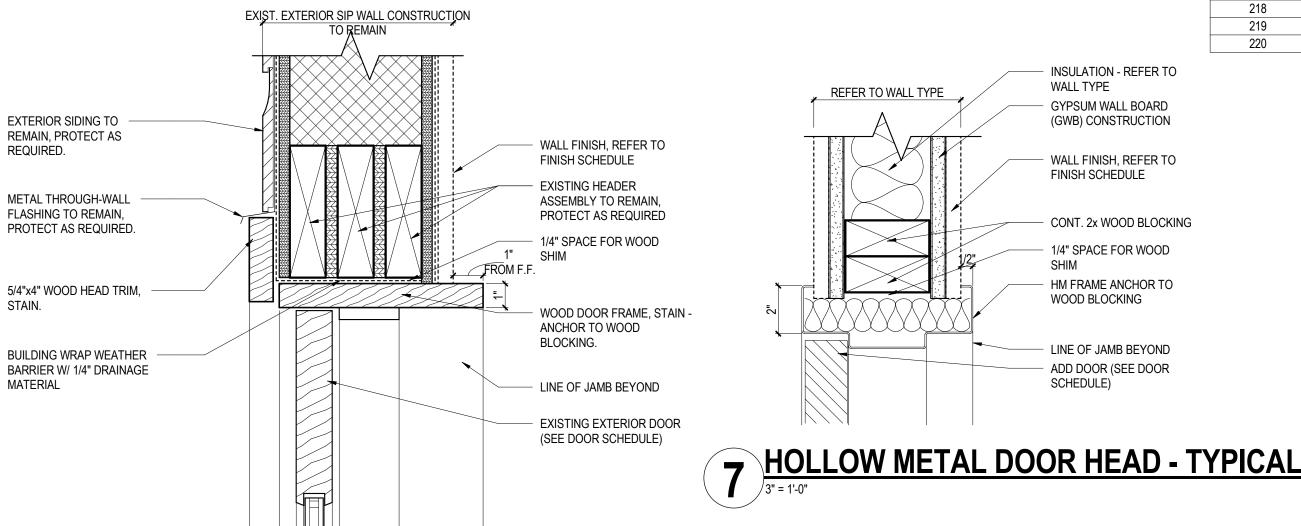

EXISTING EXTERIOR DOOR

(SEE DOOR SCHEDULE)

8 HOLLOW METAL DOOR JAMB - TYPICAL
3" = 1'-0"

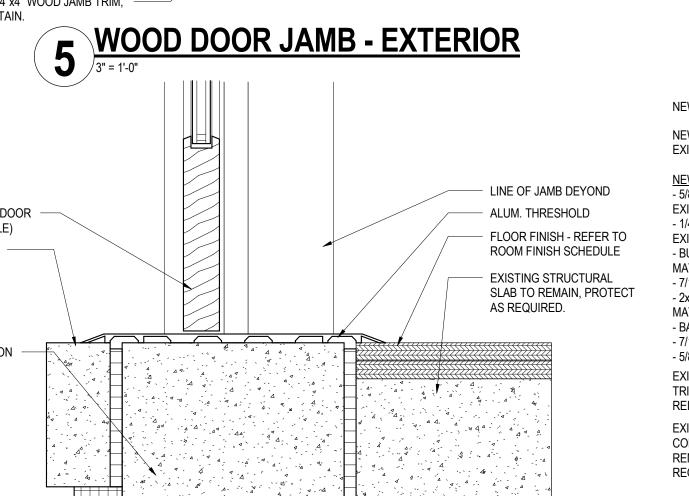

CONT. 2x WOOD BLOCKING

NEW WOOD TRIM TO MATCH EXIST. NEW WOOD BASE TRIM TO MATCH NEW EXTERIOR WALL CONSTRUCTION - 5/8" PLYWOOD - FINISHED TO MATCH EXISTING WOOD DOOR EXISTING DOOR TRIM. TRIM TO BE REMOVED & - 1/4" DRAINAGE MATERIAL TO MATCH REINSTALLED - BUILDING WRAP WEATHER BARRIER TO EXISTING EXTERIOR SIP MATCH EXIST. CONSTRUCTION TO - 7/16" PLYWOOD REMAIN, PROTECT AS - 2x WOOD STUDS @ 16" O.C., RIP TO MATCH WIDTH OF EXIST. SIP PANEL REQUIRED. - BATT INSULATION [R-20 MINIMUM] - 7/16" PLYWOOD - 5/8" GWB - PRIME & PAINT. EXISTING WOOD DOOR TRIM TO BE REMOVED & REINSTALLED **EXISTING EXTERIOR SIP** CONSTRUCTION TO REMAIN, PROTECT AS REQUIRED.

EXISTING EXTERIOR DOOR (SEE DOOR SCHEDULE) EXISTING EXTERIOR BOARDWALK EXISTING FOUNDATION

6 DOOR THRESHOLD - EXTERIOR
3" = 1'-0"

10 DOOR INFILL - PLAN DETAIL

NEW DOOR

HM FRAME ANCHOR TO

MANUFACTURER: SHERWIN WILLIAMS COLOR: SW 6072 VERSATILE GRAY PAINT 2 - GWB CEILINGS

MANUFACTURER: SHERWIN WILLIAMS COLOR: SW 7007 CEILING BRIGHT WHITE FINISH: SATIN

FINISH MATERIAL LIST

PORCELAIN FLOOR TILE 1

COLLECTION: NEOSPECK

COLOR: LIGHT GRAY NE03

SIZE: 12"X24"

MANUFACTURER: AMERICAN OLEAN

INSTALL: STAGGERED BRICK JOINT

PORCELAIN TILE WALL BASE 1

COLLECTION: NEOSPECK

COLOR: LIGHT GRAY NE03

SIZE: 6"X12" COVE BASE

PORCELAIN WALL TILE 2

MANUFACTURER: DALTILE

GROUT: LATICRETE MINK 95

PORCELAIN WALL TILE 2

MANUFACTURER: DALTILE

INSTALL: SUBWAY & ACCENT

GROUT: LATICRETE MINK 95

LOCATION: SHOWER WALLS AND

WOOD BASE

SIZE: 12"X24"

SIZE: 4"X12"

INSTALL: SUBWAY

MANUFACTURER: AMERICAN OLEAN

GROUT: LATICRETE STERLING SILVER 78

COLLECTION: SYNCHRONIC - TEXTURED

COLLECTION: MYTHOLOGY - UNDULATED

COLOR: TITAN MY96 - UNDULATED

COLOR: WHITE SY30 - TEXTURED

INSTALL: COVE BASE, PROVIDE COVE BASE CORNER

LOCATIONS: REFER TO DETAILS AND ELEVATIONS

GROUT: LATICRETE STERLING SILVER 78

FLOOR FINISHES

BASE FINISHES

WALL FINISHES

CTB-1

CT-1

PAINT 3 - DOORS AND FRAMES MANUFACTURER: SHERWIN WILLIAMS COLOR: COORDINATE WITH OWNER FINISH: SEMI GLOSS

LOCATION: OFFICE & CORRIDOR PLASTIC LAMINATE 2 MANIFACTURER: WILSONART

COLOR: HARVEST MAPLE 7953-38 LOCATION: BATHROOMS SOLID SURFACE 1

PLASTIC LAMINATE 1

MANUFACTURER: WILSONART

COLOR: WINDSWEPT PEWTER 4795-60

MANUFACTURER: CORIAN COLOR: SORREL LOCATIONS: COUNTERS & BACKSPLASH AT OFFICE CASEWORK AND RECEPTION DESK

SOLID SURFACE 2 MANUFACTURER: CORIAN COLOR: EVENING PRIMA

LOCATIONS: COUNTERS & BACKSPLASH AT BATHROOMS HARDWARE 1

MANUFACTURER: RICHELIEU STYLE: CONTEMPORARY METAL PULL 5632 FINISH: MATTE CHROME SIZE: 6 9/16" L

ACCESSORIES


CASEWORK FINISHES


JOINT TRANSITION 1 MANUFACTURER: SCHLUTER SYSTEMS PROFILE: JOLLY MATERIAL: ALUMINUM FINISH: BRUSHED NICKEL


LOCATIONS: TILE WALL OUTSIDE CORNERS TOP OF EXPOSED EDGE TILES JOINT TRANSITION 2 MANUFACTURER: SCHLUTER SYSTEMS


PROFILE: DECO MATERIAL: ALUMINUM FINISH: BRUSHED NICKEL LOCATIONS: AT FLOORS IN BATHROOM DOOR OPENINGS AT BATHROOM WALLS BETWEEN CT-2 & CT-3 AND

DOCUMENTS

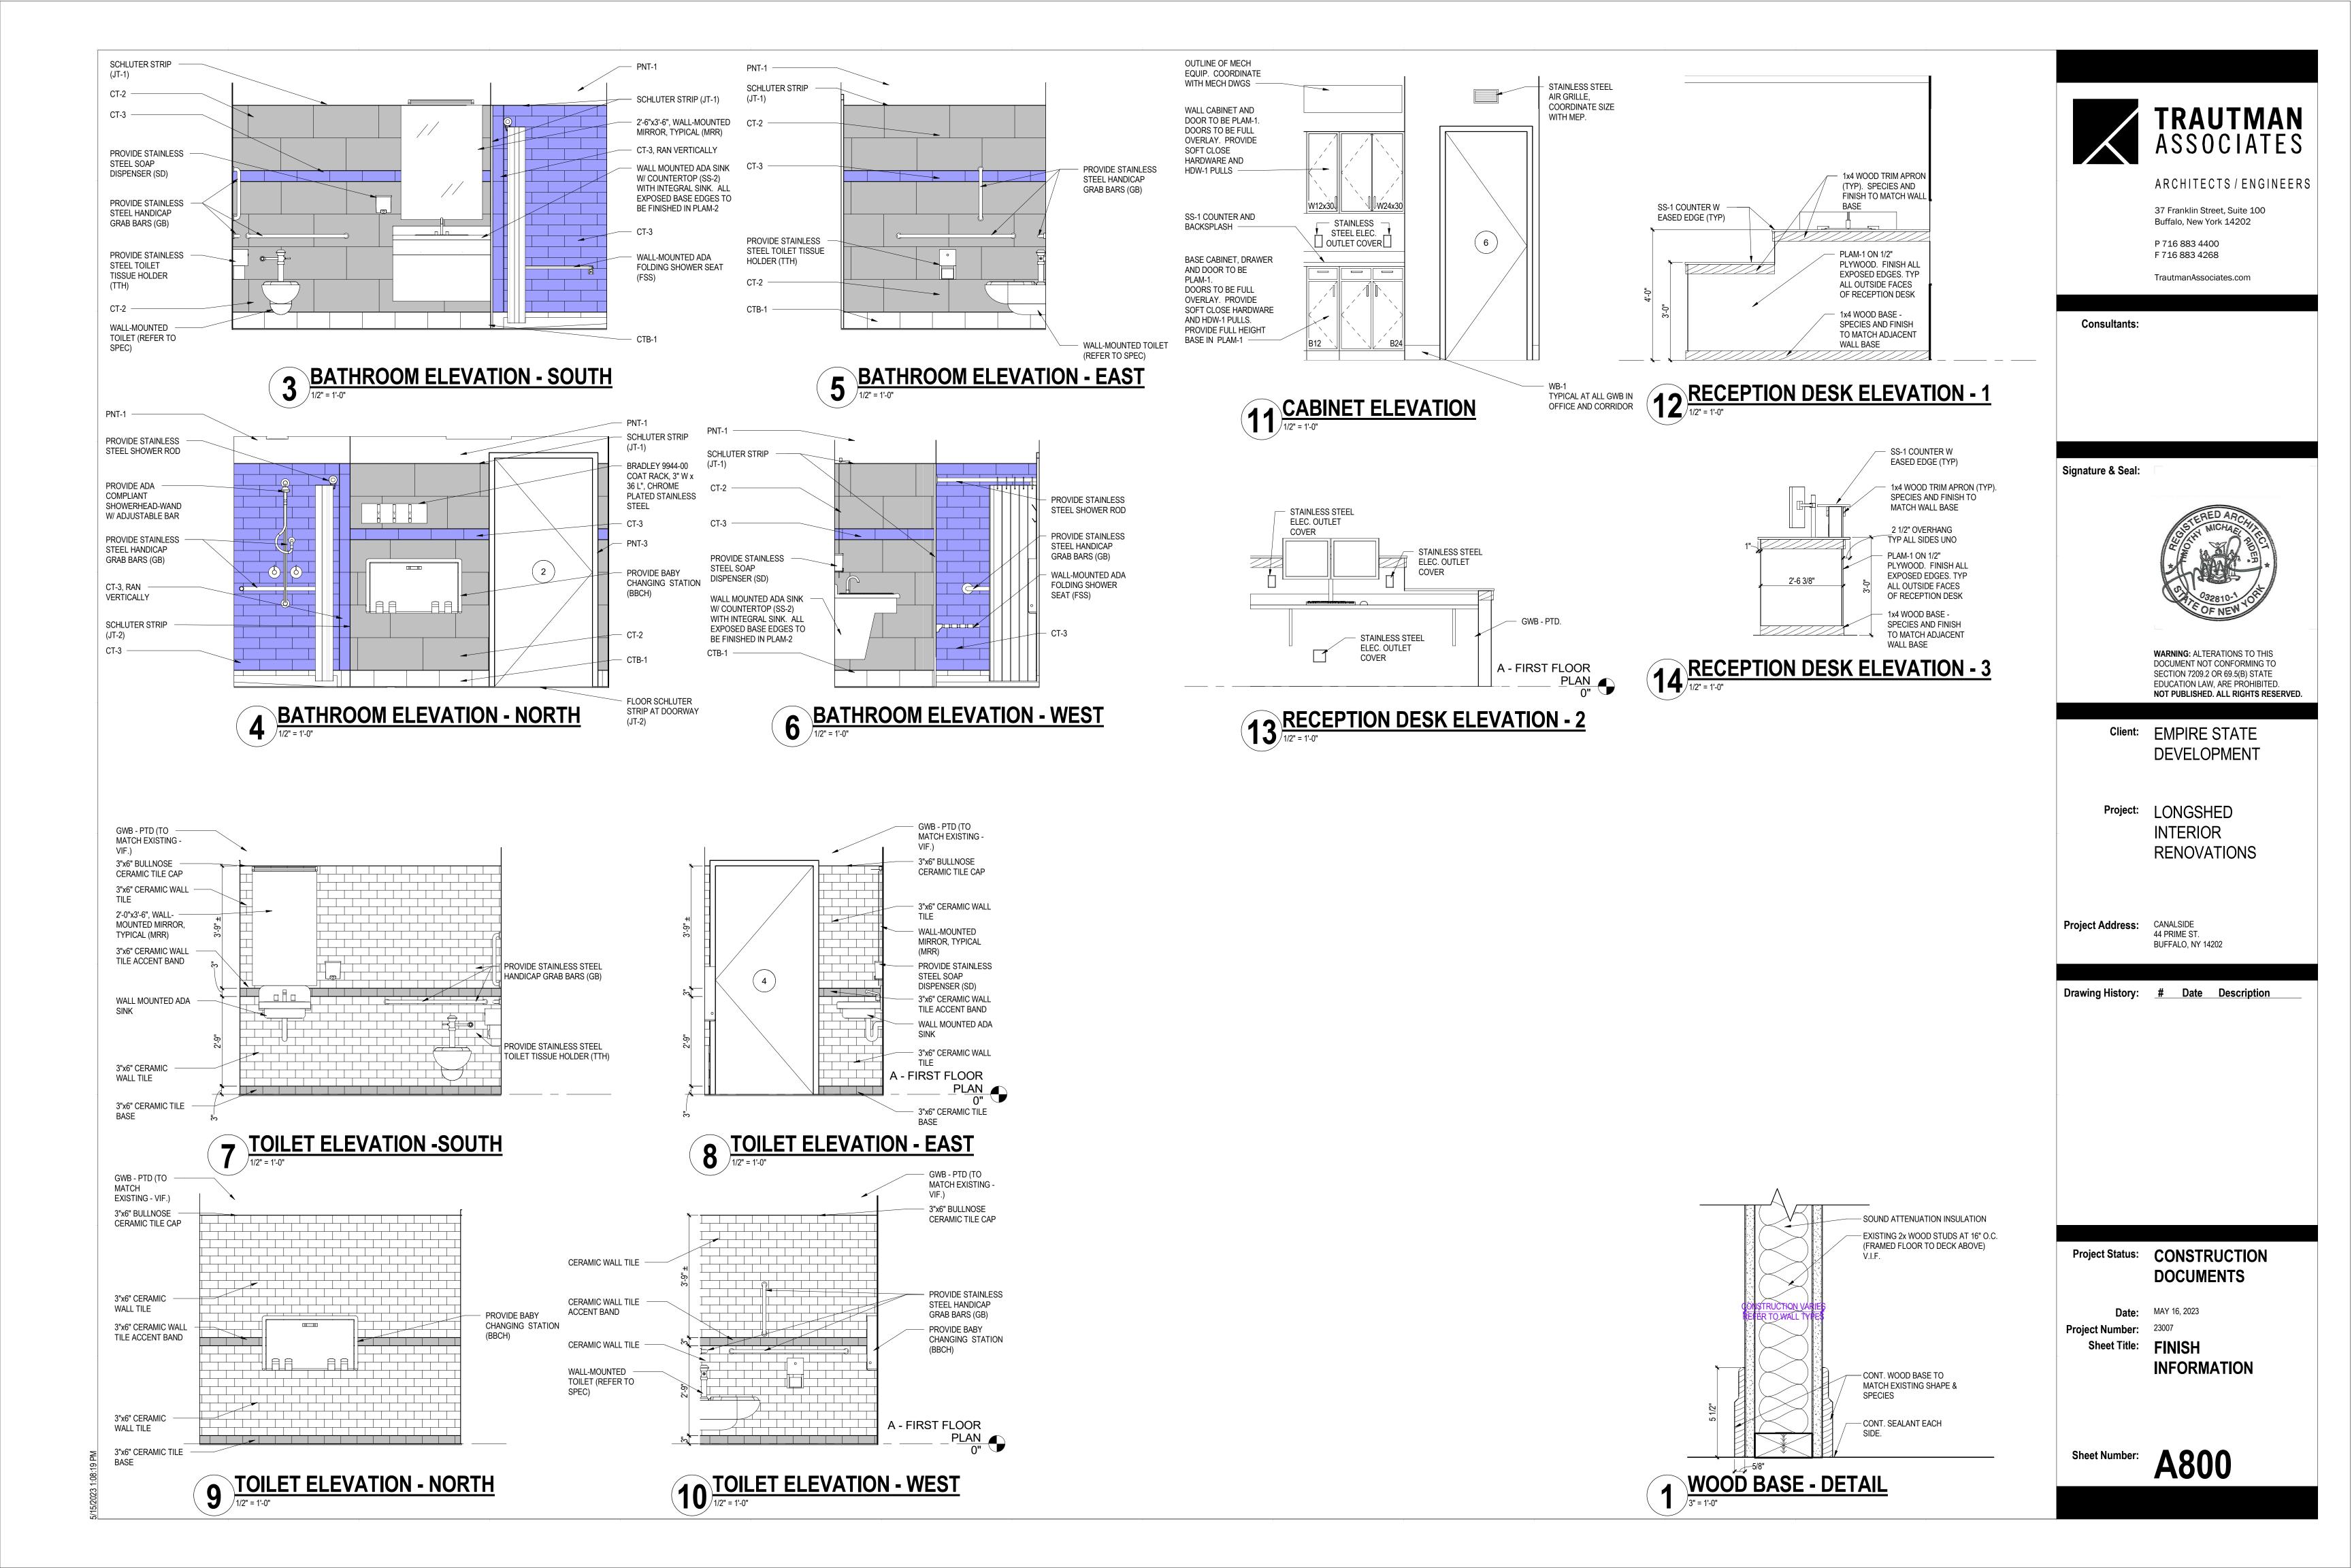


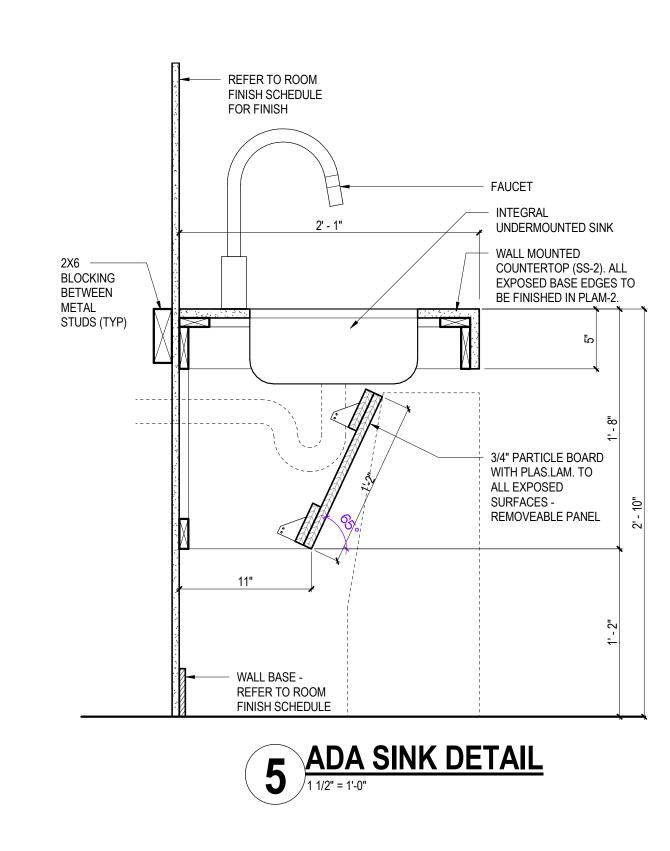

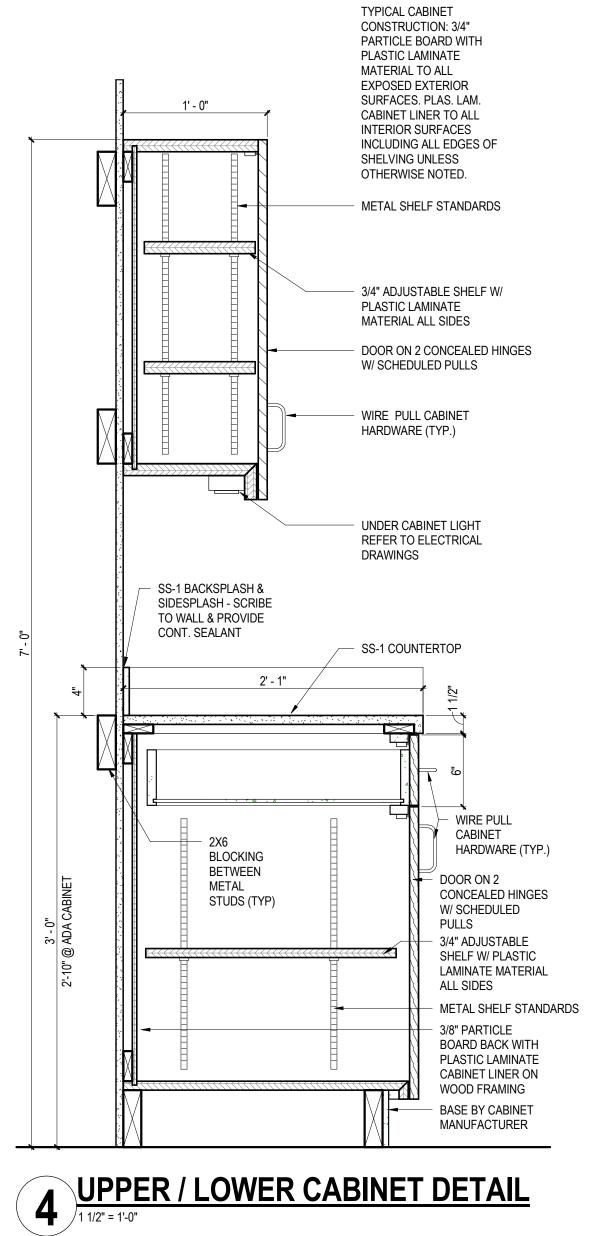


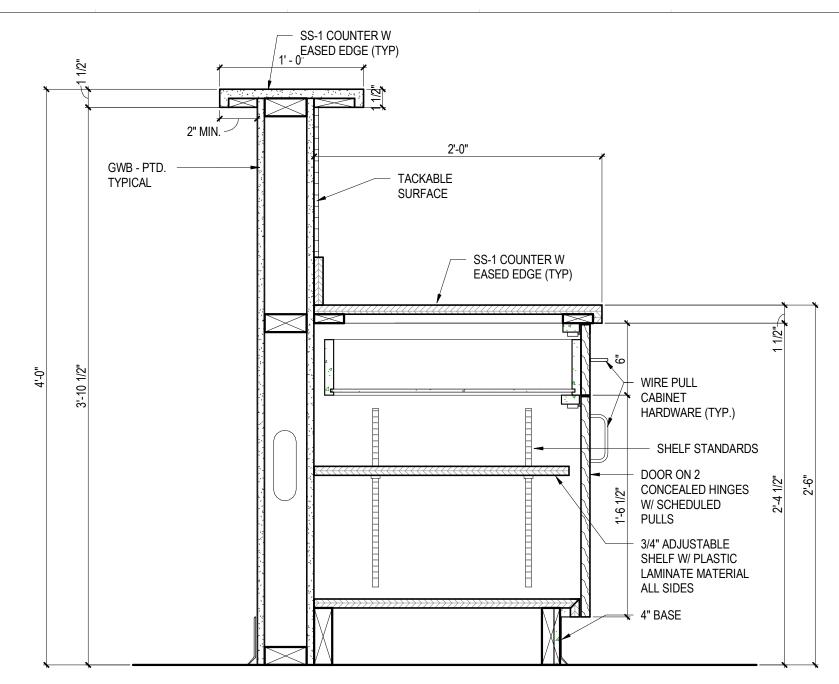

3 SECURITY DESK DETAIL W/ CABINET 1 1/2" = 1'-0"

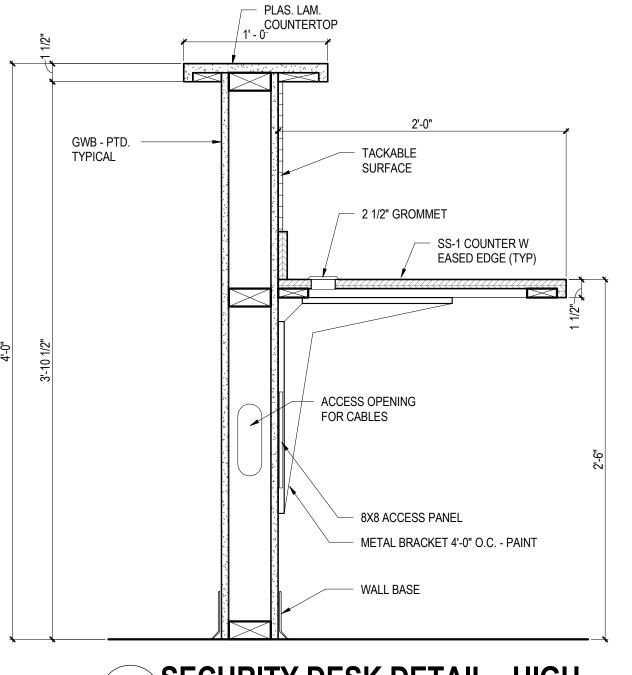

2 SECURITY DESK DETAIL - HIGH

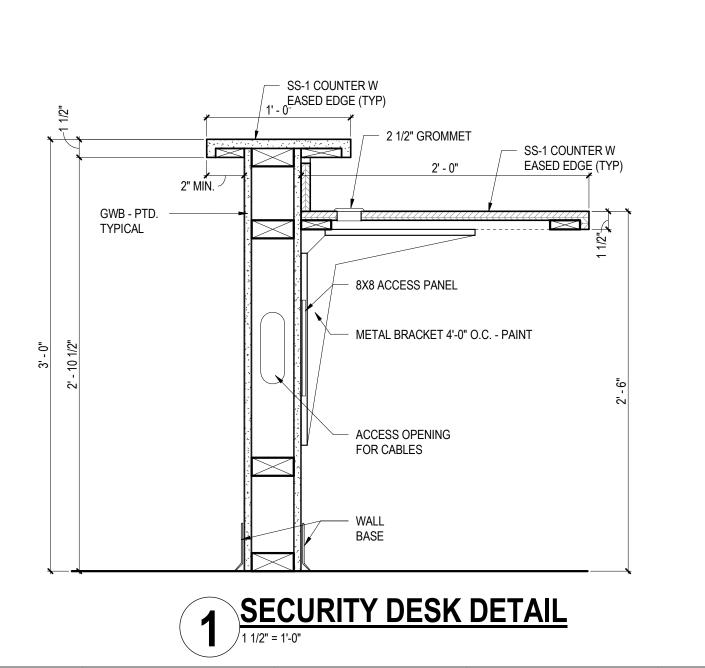



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Consultants:

Signature & Seal:



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Client: EMPIRE STATE DEVELOPMENT

Project: LONGSHED INTERIOR

BUFFALO, NY 14202

RENOVATIONS

Project Address: CANALSIDE 44 PRIME ST.

Drawing History: # Date Description

Project Status: CONSTRUCTION DOCUMENTS

Date: MAY 16, 2023
Project Number: 23007

Sheet Title: MILLWORK

Sheet Number: A801

5/2023 1:08:20 PM

	<u> </u>	XHAUST FAN SCHEI	DOLE
UNIT NUMBE	R	EF-1	EF-2
SERVICE		BATHROOM	ACC-1
FAN	CFM	20-80	2000 CFM
	SP	.15"	.15"
	RPM		
	TYPE	CEILING FAN	WALL MOUNTED
	DRIVE	DIRECT	DIRECT
	SONES	LESS THAN 1 SONE	
	DISCHARGE ARRANGEMENT	TOP OUTLET	
MATERIAL	HOUSING	ALUMINUM	ALUMINUM
	WHEEL	ALUMINUM	ALUMINUM
MOTOR	HP		1/4"
	ELECTRICAL	120 V / 1 / 60	120 V / 1 / 60
	FLA		5.8 A
MAKE	•	BROAN	GREENHECK
MODEL		AE50110DCL	SE1-18-424-B
REMARKS:		WITH INTAGRATED LIGHT - CONTROLLED ON LIGHT SWITCH	TO TURN ON WHEN ACC-1 IS ON / PROVIDE WITH WALL SLEEVE.

REGIST	ER/D	IFFUSER SC	CHEDULE
JNIT NO.		SR-1	ER-1
SERVICE		SUPPLY REGISTER	EXHAUST GRILLE
CORE TYPE		LOUVERED FACE	LOUVERED FACE
FACE		LOUVERED	LOUVERED
DAMPER		NO	NO
MOUNTING	DUCT		
	WALL		
	CEILING	Х	Х
	FLOOR		
CONSTRUCTION	FRAME	ALUMINUM	ALUMINUM
	CORE	STEEL	STEEL
	FINISH	WHITE POWDER COAT	WHITE POWDER COAT
MAKE		PRICE	PRICE
MODEL		600 - SUPPLY	600 - RETURN
ACCESSORIES			
REMARKS			

BASEBOARD S	SCHEDULE
LETTER INDICATION	BB-1
SERVICE	RADIANT HEAT
CAPACITY (BTUH/LF)	160 CFM
AVG WATER TEMP (°F)	YES
ENT. AIR TEMP (°F)	WHITE
ENT. WATER TEMP (°F)	16" X 22" X 2"
LVG WATER TEMP (°F)	6825
FLUID	
ACCESSORIES	
MAKE	ZEHNDER RITTLING
MODEL	PRF-4
REMARKS	
NOTES: CONTRACTOR MAY SUBMIT EQUAL FO	OR APPROVAL

HVAC SYMBOLS / ABBREVIATIONS LEGEND:

	NEW WORK	——⊗—— BALANCING VALVE	
N()——	CHILLED WATER(S-SUPPLY, R-RETURN)	UNION	
N()——	HOT WATER(S-SUPPLY, R-RETURN)		
C()——	HOT/CHILLED WATER(S-SUPPLY, R-RETURN)	STRAINER, BLOW OFF	
D——	CONDENSATE DRAIN	——————————————————————————————————————	
	CAP	♀	
——O	RISE	PRESSURE GAUGE	
—∋ —	DROP TEE - OUTLET UP	EXPANSION LOOP	
	TEE - OUTLET OWN	AUTOMATIC AIR VENT	
<u></u>	BRANCH - TOP CONNECTION	J₁ MV	
	BRANCH - BOTTOM CONNECTION	MANUAL AIR VENT	
+ ,	BRANCH - SIDE CONNECTION	AIR SEPARATOR	
×	ANCHOR		
—	EXPANSION JOINT	—— ∏fs FLOW SWITCH	
=	PIPE GUIDE	THERMOMETER	
	FLOW - IN DIRECTION OF ARROW	<u> </u>	
5	BALL VALVE	FD FLOOR DRAIN	
Γ	BUTTERFLY VALVE	T THERMOSTAT	
5	PLUG VALVE	Temperature sensor (Duct)	
PS	PRESSURE SWITCH	T TEMPERATURE CONTROLLER	
>	PUMP (INDICATE USE)	SD SMOKE DETECTOR	
)	UNIT HEATER	C CAP	
ጉ	UNITTIEATEN	POINT OF REMOVAL POINT OF CONNECTION	
	MOTOR OPERATED DAMPER	SUPPLY DIFFUSER (CEILING)	
D E OR P		RETURN / EXHAUST GRILLE(CEILING	i)
<u>a</u>)	DOOF VENTUATOR INTAKE	DUCT SECTION, POSITIVE PRESSUR	Έ
SRV-1	ROOF VENTILATOR, INTAKE	DUCT SECTION, NEGATIVE PRESSU	RE
ERV-1	ROOF VENTILATOR, EXHAUST	DIRECTION OF FLOW	
	ROOF VENTILATOR, LOUVERED	DUCT SIZE	
	TROOF VERTILE HOTELES		
IR OUTLE	T / INLET SYMBOL	CHANGE OF ELEVATION	
CFM		ACCESS DOOR	
CFIVI	600 CFM	ACOUSTICAL LINING	
	SD - 1 8"	BACK DRAFT DAMPER	
DEVI	CE — SIZE	VERTICAL POSTITION FIRE DAMPER	
	\ TYPE	HORZONTAL POSTITION DAMPER	
	THREE WAY VALVE	MANUAL VOLUME DAMPER	
<u></u>	GATE VALVE		
√	VALVE	MANUAL SPLITTER DAMPER	
√ <u>ID</u>	TRIPLE DUTY VALVE	SMOKE DAMPER	
■	GLOBE VALVE	STANDARD BRANCH (S-SUPPLY, R-F	FTIII
↓	2-WAY CONTROL VALVE	OTANDAND BINNOT (0-30FFLT, N-F	.∟ i Ul
├	CHECK VALVE	LINEAR DIFFUSER	
√ —	PRESSURE REDUCING VALVE RELIEF VALVE	TRANSITION	
		TURNING VANES	
		FLEXIBLE CONNECTION	


AD AFF	ACCESS DOOR ABOVE FINISHED FLOOR
AHU	AIR HANDLING UNIT
AI AS	AIR INTAKE AIR SEPARATOR
AV	AIR VENT
BD	BALANCING DAMPER BACKDRAFT DAMPER
BFP	BACK FLOW PREVENTOR
CD	CONDENSATE DRAIN
CFM CLG	CUBIC FEET PER MINUTE CEILING
	CABINET UNIT HEATER
CW	COLD WATER
	CHILLED WATER PUMP EXHAUST FAN
EG	EXHAUST GRILLE
	EXHAUST REGISTER EXPANSION TANK
	FAN COIL
FD FR	FIRE DAMPER FINNED TUBE RADIATION
GPM	
HUH	HORIZONTAL UNIT HEATER
HWP HWR	HOT WATER PUMP HOT WATER RETURN
HWS	HOT WATER SUPPLY
LRR LSR	LINEAR RETURN REGISTER LINEAR SUPPLY REGISTER
_	1,000 BRITISH THERMAL UNITS (C-COOLING, H-HEATING)
MOD NC	MOTOR OPERATED DAMPER NORMALLY CLOSED
NO	NORMALLY OPENED
OED	OPEN END DUCT
P PF	SYSTEM PUMP PROPELLER FAN
PRV	PRESSURE REGULATING VALVE
RD RF	RETURN DIFFUSER ROOF FAN
RG	RETURN GRILLE
RR	RETURN REGISTER
RV SR	RELIEF VENT SUPPLY REGISTER
SHWP	SECONDARY HOT WATER PUMP
SD TC	SUPPLY DIFFUSER TEMPERATURE CONTROL
TG	TRANSFER GRILLE
TYP	TYPICAL
TV UH	TURNING VANES UNIT HEATER
WC	WATER CHILLER
VD	VOLUME DAMPER

	CONDE	ENSER SCHEDULE			
UNIT NO.		ACC-1			
NOMINAL COOLING CAPA	ACITY (BTU/H)	24000			
NUMBER OF PORTS		3-PORT			
ELECTRICAL	VOLTS / PHASE / HERTZ	208-230 / 1 /60			
	MCA	23 A			
	RLA	17.5 A			
	RECOMMENDED BREAKER SIZE	25 A			
REFRIGERANT PIPING	LIQUID (INCHES)	<u>1</u> " X 3			
	GAS (INCHES)	3" X 1 / 1" X 2			
	H/L PRESSURE CONNECTION (INCHES)				
	MAX TOTAL REFRIGERANT PIPE LENGTH (FT)	230'			
	TYPE	R410A			
NET WEIGHT (LBS)		140 LBS			
DIMENSIONS (INCHES)	HEIGHT X WIDTH X DEPTH	38" X 14" X 29"			
MANUFACTURER	•	DAIKIN			
MODEL		3MXL24RMVJU			
NOTES:		PROVIDE DISCONNECT SWITCH WITH UNIT - UNIT TO BE COOLING ONL			

INDO	OR FAN COIL UNIT	SCHEDULE	
UNIT NO.		FCU-1	FCU-1
UNIT TYPE		CASSETTE	WALL-MOUNTED
NOMINAL COOLING CAPACITY	BTU/H	9000	9000
NOMINAL HEATING CAPACITY	BTU/H	-	
FAN	TYPE	BLDC	BLDC
	AIRFLOW RATE CFM	330	200
	WATTS	23	18
ELECTRICAL	VOLTAGE, PHASE, HERTZ	208-230 / 1 / 60	208-230 / 1 / 60
MCA	A	.23	.09
MOP	A	15	15
REFRIGERANT PIPING DIMENSIONS	LIQUID (HIGH PRESSURE)	1/4"	1/4"
	SUCTION	3/8"	3/8"
DRAIN PIPE DIMENSIONS		1-1/2"	1-1/2"
SOUND PRESSURE LEVELS	DB(A)	28	30
NET WEIGHT	LBS	36	20
DIMENSIONS (IN)	LENGTH X WIDTH X HEIGHT	22-5/8" X 22-5/8" X 11-3/4"	32" X 8-7/16" X 11-5/8"
MANUFACTURER		DAIKIN	DAIKIN
MODEL		FFQ09Q2VJU	FTXS09LVJU
NOTES:		PROVIDE CONDENSATE PUMP WITH UNIT	PROVIDE CONDENSATE PUMP WITH UNIT

GENERAL NOTES:

- A. THESE DRAWINGS ARE DIAGRAMMATIC IN NATURE AND INDICATE THE SIZE AND GENERAL ARRANGEMENT OF PIPING, DUCTWORK, EQUIPMENT ETC. EXACT LOCATIONS AND ROUTINGS SHALL BE DETERMINED IN THE FIELD BEFORE AND AS THE WORK PROGRESSES. CAREFULLY COORDINATE THE WORK OF THIS TRADE WITH ALL OTHER TRADES.
- DRAWING DO NOT INDICATE ALL OFFSETS, CHANGES IN ELEVATION ETC WHICH MAY BE REQUIRED BY ACTUAL FIELD CONDITIONS. THE CONTRACTOR IS TO FIELD VERIFY EXISTING CONDITIONS PRIOR TO INSTALLATION AND MAKE SUCH CHANGES IN PIPING, DUCTWORK, EQUIPMENT LOCATIONS, ETC. AS NECESSARY TO ACCOMMODATE EXISTING CONDITIONS. COORDINATE ALL CHANGES WITH OTHER TRADES, AND ARCHITECT.
- ALL CUTTING AND PATCHING OF EXISTING BUILDING COMPONENTS REQUIRED TO ACCOMMODATE THE WORK OF THIS CONTRACT SHALL BE THE RESPONSIBILITY OF THIS TRADE. ALL PATCHING SHALL MATCH EXISTING COMPONENTS AND FINISHES. WORK SHALL BE PERFORMED BY PERSONNEL TRAINED AND REGULAR EMPLOYED FOR SUCH SERVICES.
- INSTALL ALL PIPING, DUCTWORK, EQUIPMENT, ETC. TO AVOID INTERFERENCE WITH THE OPERATION AND SERVICING OF ALL NEW AND EXISTING EQUIPMENT. IN GENERAL, DO NOT INSTALL ANYTHING ABOVE OR WITHIN 3 FT IN FRONT OF ELECTRICAL PANELS AND GEAR.
- FIRESTOP ALL PIPING PENETRATIONS THRU FLOORS AND WALLS. SEE DETAILS ON LEGEND, SCHEDULES, DETAIL SHEET AND SPECIFICATION DIVISION 7.
- THE WORK INCLUDED IN THIS CONTRACT ENCOMPASSES BOTH THE DRAWINGS AND SPECIFICATIONS. WORK INCLUDED ON THE DRAWINGS ONLY, OR IN THE SPECIFICATIONS ONLY. SHALL BE INCORPORATED AS IF INCLUDED IN BOTH SYSTEMS ARE INTENDED TO BE COMPLETE AND FULLY FUNCTIONING. IT IS NOT INTENDED TO SHOW EVERY ITEM OF WORK OR MINOR PIECE OF EQUIPMENT. THE CONTRACTOR SHALL PROVIDE SUCH COMPONENTS, ETC. AS NECESSARY OR REQUIRED FOR A FULLY FUNCTIONING SYSTEM, IN ACCORDANCE WITH THE BEST PROFESSIONAL PRACTICE OF THE TRADE.
- EACH PRIME CONTRACTOR IS RESPONSIBLE FOR PROVIDING THEIR OWN FLOOR PENETRATIONS. PRIOR TO MAKING ANY CONCRETE FLOOR SLAB PENETRATIONS EACH CONTRACTOR SHALL SCAN THE SLAB USING A "REBAR LOCATING DEVICE" TO LOCATE EXISTING REINFORCING STEEL, UTILITIES, AND OTHER EMBEDMENTS WITHIN OR BELOW THE SLAB. LOCATION OF ALL PENETRATIONS SHALL BE ADJUSTED TO AVOID DISTURBING OR CUTTING ANY EXISTING SLAB REINFORCING STEEL, UTILITIES, AND OTHER EMBEDMENTS WITHIN OR BELOW THE SLAB. PROVIDE SCAN RESULTS TO THE ARCHITECT/ENGINEER AND OTHER CONTRACTORS.

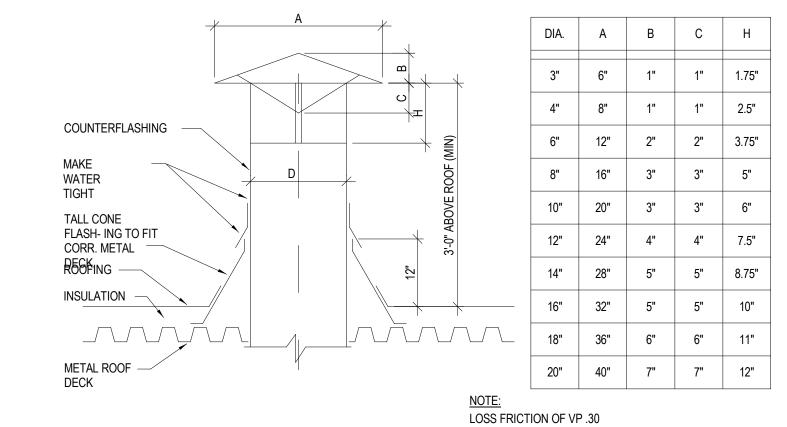

NOTES:

NEW ROOF

1. ROOF OPENING & FRAMING BY G.C.

2. ROOF FLASH & COUNTER FLASH BY G.C.

1 FLUE / VENT DETAIL



ARCHITECTS / ENGINEERS

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> Client: EMPIRE STATE DEVELOPMENT

Project: LONGSHED INTERIOR RENOVATIONS

Project Address: CANALSIDE
44 PRIME STREET
BUFFALO, NY 14202

Drawing History: # Date Description


Project Status: NOT FOR CONSTRUCTION


Date: MAY 16, 2023

Sheet Title: MECHANICAL SCHEDULES, SYMBOLS, AND **LEGENDS**

Sheet Number:

M001

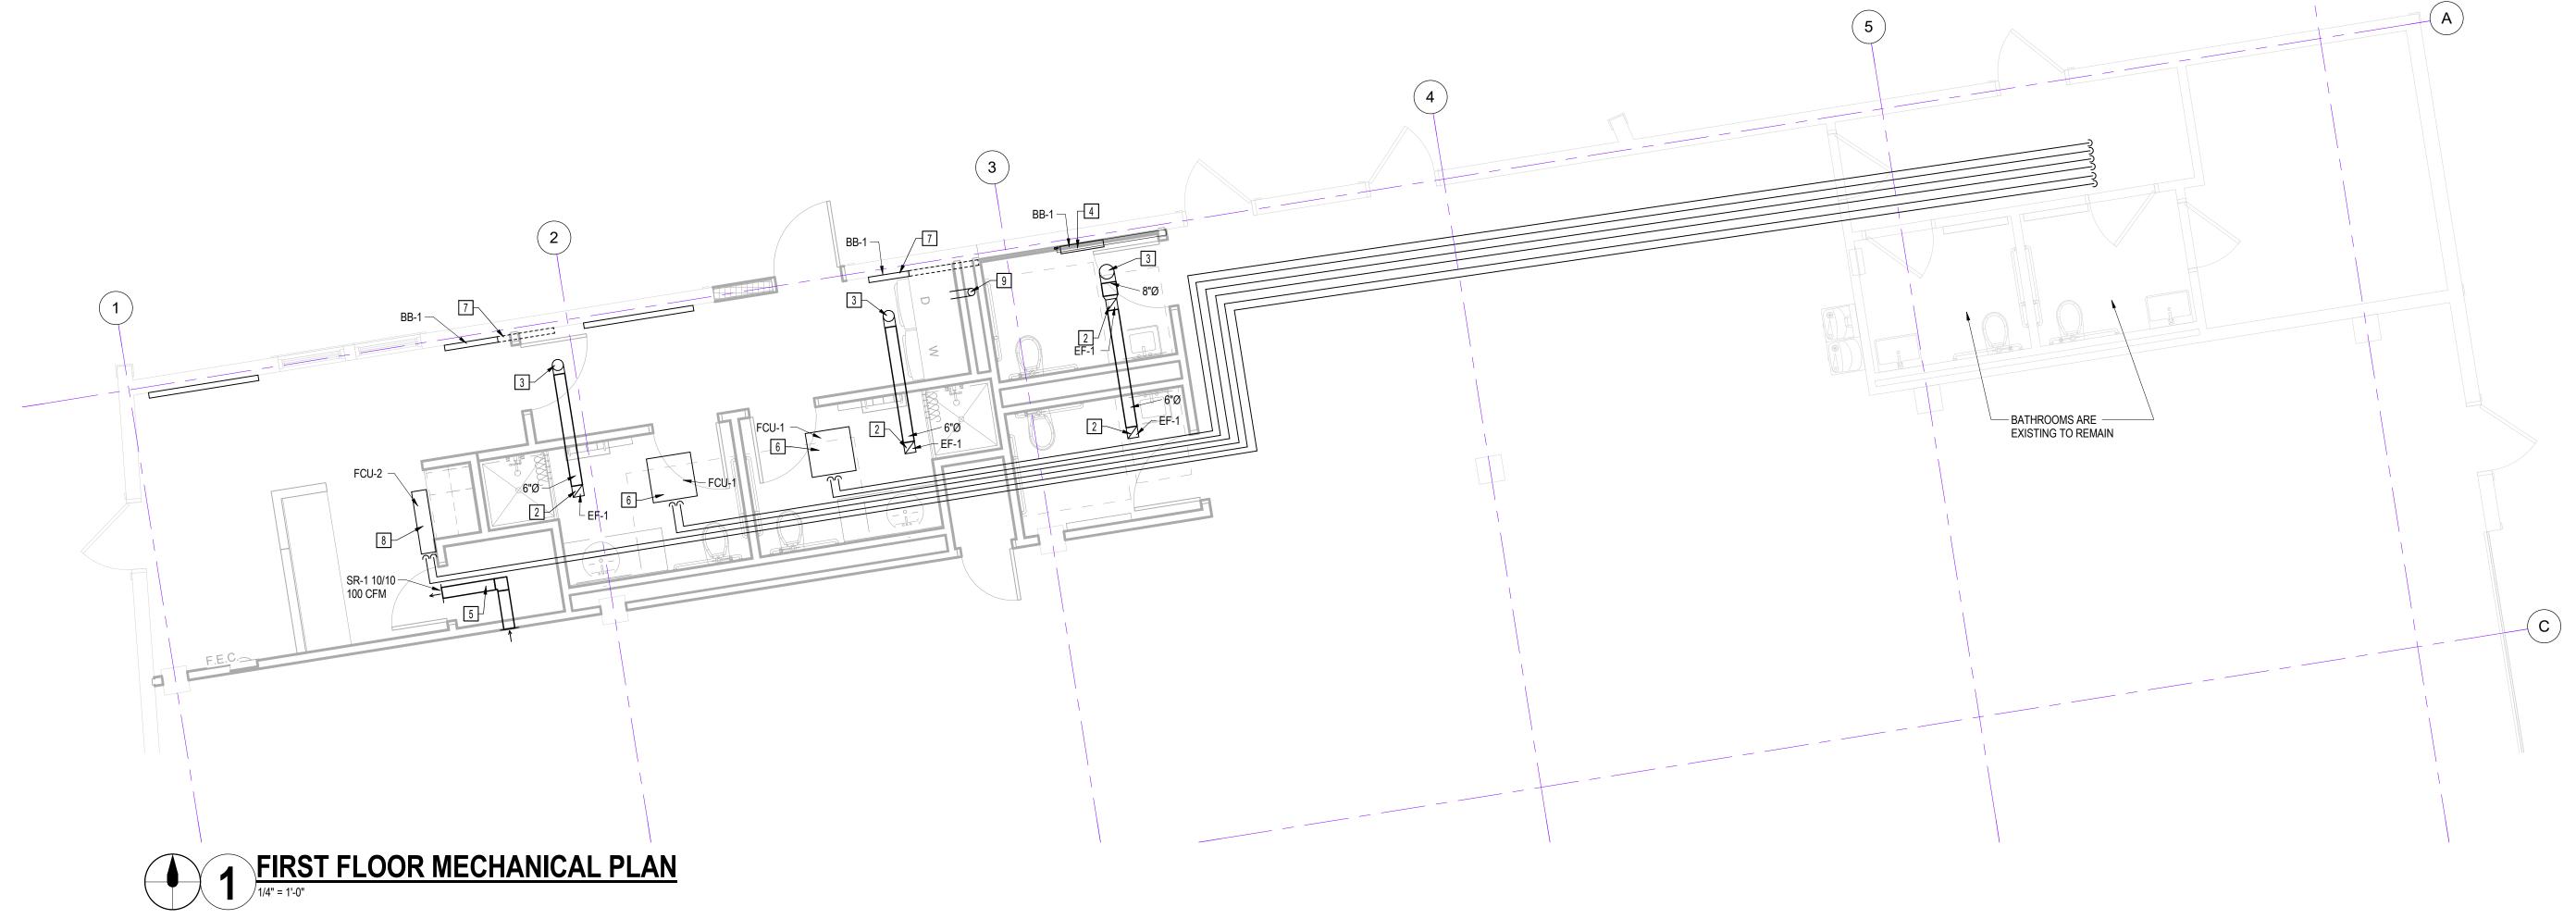

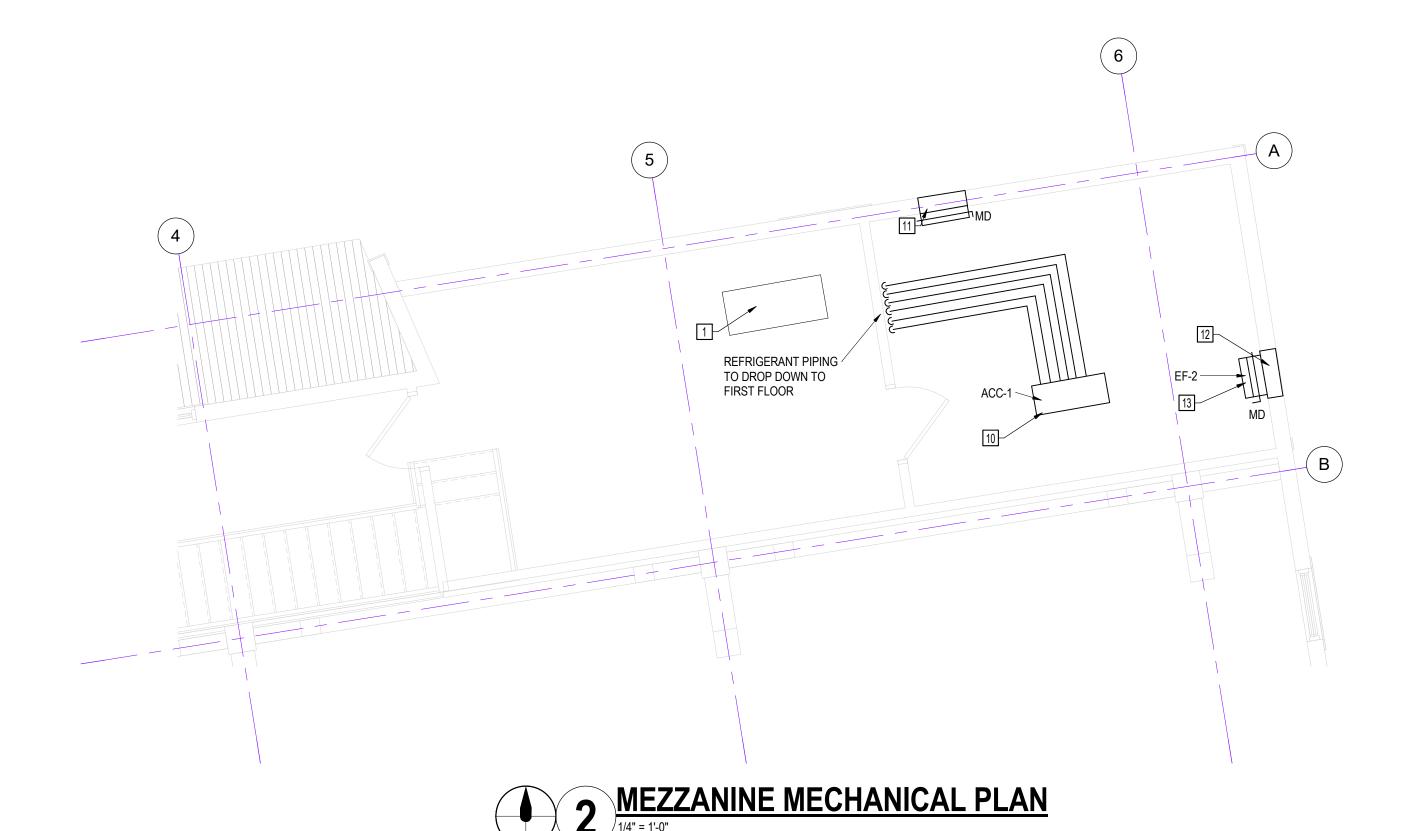

- 1. COORDINATE ALL WORK WITH EACH REQUIRED CONTRACTOR PRIOR TO INSTALLATION. 2. IF ANY CHANGES ARE MADE TO THESE DOCUMENTS, ENGINEER OF RECORD IS TO APPROVE THIS CHANGE.
- 3. WORK IS TO FOLLOW ALL LATEST 2020 CODE ADAPTATIONS.

MECHANICAL DRAWING NOTES:

- 1. ERV LOCATED ON MEZZANINE ABOVE. ERV IS BALANCED TO 1600 CFM SUPPLY AND RETURN AIR. REBALANCE THE UNIT TO PROVIDE 1800 CFM OF SUPPLY AIR. RETURN AIR
- 2. BATHROOM EXHAUST FAN TO HANG IN CEILING. UNIT TO BE A CONSTANT VOLUME FAN. UNIT TO RAMP UP TO 80 CFM WHEN THE LGHT IS TURNED ON. UNIT TO RUN AT A CONSTANT 20 CFM WHEN THE LIGHT IS OFF. INSTALL PER MANUFACTURERS INSTRUCTIONS.
- 3. EXHAUST DUCT THROUGH OVERHANG ABOVE. DUCT TO BE PROVIDED WITH WEATHERPROOF MUSHRROM CAP AT ROOF ABOVE. REFER TO DETAIL 1 ON M-001 FOR
- 4. PROVIDE 2' SECTION OF FIN-1 NOTED ON THE SCHEDULES PAGE. 1/2" HWS AND HWR TO BE RUN FROM MEZZANINE ABOVE. PROVIDE MANUAL FLOW SETTER ON SUPPLY LINE. INSULATE PIPING AS REQUIRED PER ENERGY CODE.
- 5. 6" TRANSFER DUCT TO TRANSFER AIR FROM MAIN WORKSHOP. PROVIDE SOUND LINER IN DUCT. DUCT TO PROVIDE 100 CFM TO NEW LOBBY/BATHROOM SPACE.
- 6. CEILING CASETTE FAN COIL TO SIT IN BATHROOM CEILING. UNIT TO BE CONTROLLED OFF THERMOSTAT BY THE DOOR. INSTALL UNIT INBETWEEN FLOOR STRUCTURE IN CEILING. INSTALL PER MANUFACTURERS INSTRUCTIONS.
- 7. REMOVE SECTION OF FINTUBE AND REINSTALL 2'6" SECTION OF BB-1 IN LOCATION
- SHOWN. INSTALL PER MANUFACTURERS INSTRUCTIONS. 8. WALL MOUNTED FAN COIL. FAN COIL TO SIT HIGH ON WALL. UNIT TO BE CONTROLLED
- OFF THERMOSTAT BY THE DOOR. INSTALL PER MANUFACTURERS INSTRUCTIONS. 9. LAUNDRY EXHAUST DUCT TO GO UP THE CHASE BEHIND THE WASHER DRYER. DUCT TO BE PROVIDED WITH WEATHERPROOF MUSHRROM CAP AT ROOF ABOVE. REFER TO DETAIL 1 ON M-001 FOR DETAIL.
- 10. AIR COOLED CONDENSER TO BE LOCATED IN THE MEZZANINE MECHAICAL ROOM. UNIT TO BE COOLING ONLY. HANG UNIT OFF STRUCTURE ABOVE WITH UNISTRUT. INSTALL UNIT PER MANUFACTURERS INSTRUCTIONS.
- 11. 3' X 3' INTAKE LOUVER TO SERVE ACC-1. COORDINATE INSTALL WITH GC. UNIT TO BE PROVIDED WITH MOTORIZED DAMPER. DAMPER TO OPEN WHEN ACC-1 IS ON. DAMPER TO FAIL CLOSED.
- 12. 3' X 3' EXHAUST LOUVER TO SERVE ACC-1. COORDINATE INSTALL WITH GC. UNIT TO BE PROVIDED WITH MOTORIZED DAMPER. DAMPER TO OPEN WHEN ACC-1 IS ON. DAMPER TO FAIL CLOSED. PROVIDE BACK DRAFT DAMPER WITH EXTERIOR LOUVER.
- 13. EXHAUST FAN TO SERVE ACC-1. FAN TO TURN ON WHEN ACC-1 IS ON.



ARCHITECTS / ENGINEERS


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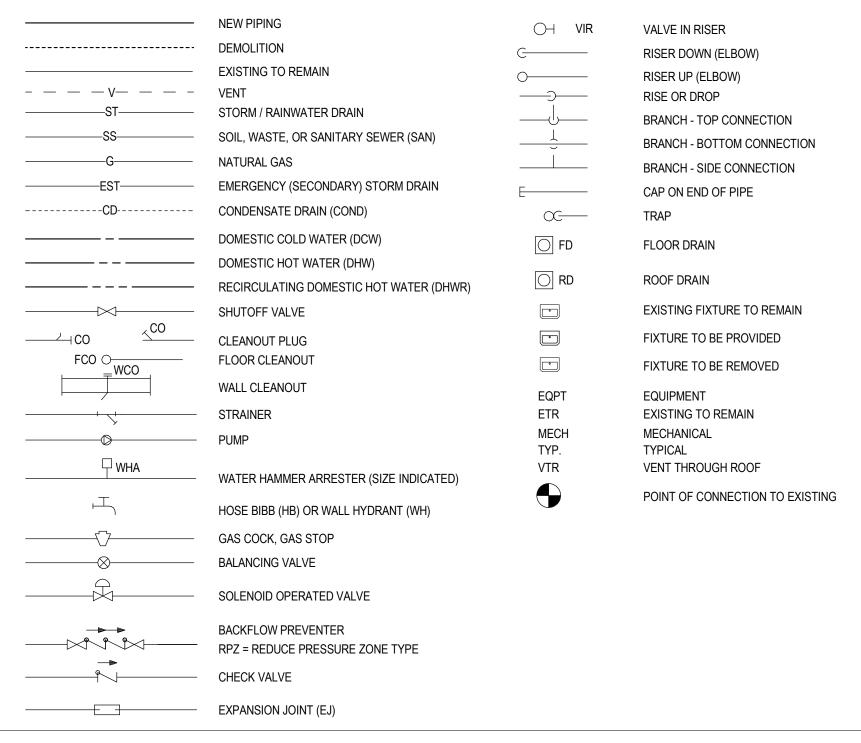
MAY 16, 2023

Sheet Title: MECHANICAL **FLOOR PLANS**

GENERAL PLUMBING NOTES:

- WHERE PIPING, FIXTURE, OR EQUIPMENT IS INDICATED TO BE PROVIDED, PROVIDE FIXTURE, PIPING, AND AL ASSOCIATED ACCESSORIES, INCLUDING SUPPLY FITTINGS, FAUCET, TRAP, SUPPORTS, HANGERS, INSULATION, ETC. EXTEND PIPING ACCORDING TO DRAWINGS AND AS NECESSARY TO CONNECT FIXTURES AND EQUIPMENT. SEE SCHEDULES AND SPECIFICATIONS FOR DETAILS.
- 2. COORDINATE INSTALLATION WITH ALL OTHER TRADES, INCLUDING OTHER PIPING, DUCTWORK, GRILLES, LIGHTS, ETC, AS WELL AS THE EXISTING STRUCTURE. CEILING SPACE IS VERY LIMITED AND INSTALLATION BE CAREFULLY COORDINATED. COORDINATE PIPING INSTALLATION IN CHASES WITH ALL OTHER CONTRACTORS.
- 3. COORDINATE ALL FLOOR PENETRATIONS WITH THE GENERAL CONTRACTOR.
- 4. INSTALL ALL MATERIALS AND EQUIPMENT ACCORDING TO MANUFACTURES INSTRUCTIONS AND RECOMMENDATIONS AND ACCORDING TO CODE.
- ALL PIPING, EQUIPMENT, AND ALL ACCESSORIES IN ALL AREAS, ARE TO BE INSTALLED TIGHT TO THE STRUCTURE TO ALLOW THE GREATEST FLOOR TO CEILING CLARENCE POSSIBLE. VERIFY EXACT ROUTING IN FIELD.
- 6. PROVIDE FIRESTOPPING AT ALL PIPE PENETRATIONS THROUGH ALL FIRE RATED ASSEMBLIES. SEE ARCHITECTURAL DRAWINGS FOR FIRE RATINGS.
- LABEL ALL PIPING, VALVES, EQUIPMENT, SPECIALTIES, ETC. ACCORDING TO CODE AND TO SPECIFICATIONS.
- INSULATE ALL PIPING ACCORDING TO NEW YORK STATE ENERGY CONSERVATION CONSTRUCTION CODE AND TO SPECIFICATIONS.
- 9. PROVIDE ALL TESTING AND ADJUSTING ACCORDING TO CODE AND TO SPECIFICATIONS.
- IO. ALL VALVES OR OTHER EQUIPMENT REQUIRING FUTURE SERVICE/MAINTENANCE ARE TO BE LOCATED IN ACCESSIBLE AREA. PROVIDE LOCKABLE ACCESS DOORS WHERE REQUIRED. COORDINATE WITH GENERAL CONTRACTOR.
- ALL PLUMBING WORK MUST BE PERFORMED IN ACCORDANCE WITH ALL APPLICABLE CODES AND ALL AUTHORITIES HAVING JURISDICTION.
- 12. PLUMBING CONTRACTOR IS RESPONSIBLE FOR SAW CUTTING OF EXISTING SLAB WHERE UNDERSLAB PIPES ARE TO BE REMOVED AND NEW PIPE IS TO BE INSTALLED, ALONG WITH REMOVAL OF ALL FILL, SUB BASE AND ANY RICK ENCOUNTERED. REFER TO DRAWINGS FOR SLAB REPAIR DETAIL. PLUMBER SHALL BE RESPONSIBLE FOR ALL SLAB REPAIR PER THE DETAIL.
- 3. ALL NEW AND EXISTING UNINSULATED PIPING THAT IS INSTALLED IN EXPOSED AREAS SHALL BE PAINTED TO MATCH THE EXISTING CONDITIONS. VERIFY COLORS IN FIELD.

PLUMBING SYMBOLS / ABBREVIATIONS LEGEND:

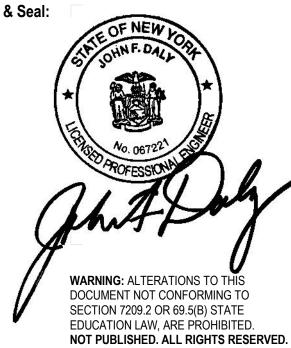

					PLUMBING	FIXTURE	SCHED	JLE				
TAG		FIXTURE	MATERIAL	TYPE	OPERATOR/ FITTING	CARRIER	DCW	DHW-140 DEG F	DHW-115 DEG F	WASTE	VENT	NOTES & ACCESSORIES
LAV-1	DESCRIPTION	LAVATORY	VITREOUS CHINA	WALL MOUNT	HARDWIRE, SENSOR FAUCET, 0.5 GPM, SIDE MIXER	NA	1/2"	NA	1/2"	1-1/4"	1-1/4"	PROVIDE QUATER TURN (BRASSCRAFT COMPRESSION) ANGLE STOPS,
LAV-1	MANUFACTURER	SLOAN		ADA COMPLAINT MOUNTING HEIGHT	SLAON MODEL # EAF-100							SINK SUPPLY HOSE CONNECTION, AND 1-1/4" x 1-1/4" P TRAP (MCGUIRE "MCT125 SERIES.)
WC-1	DESCRIPTION	WATER CLOSET	VITREOUS CHINA	WALL MOUNT, REAR SPUD FLUSH VALVE, SLOANTEC GLAZE	REAR SPUD, 1.28 GPF, HARDWIRE SENSOR, CONCEALED	WATTS ADJUSTABLE	1"	NA	NA	4"	2"	PROVIDE OPEN FRONT, ELONGATED WHOTE TOILET SEAT. COORDIANTE INSTALL WITH ELECTRICAL CONTRACTOR. PROVIDE ANY ADDITONAL
	MANUFACTURER	SLOAN		MODEL # ST-2459-STG	SLOAN ROYAL 152 ESS28							ACCESSORIES INCLDUNG LOW VOLTAGE WIREING AND TRANSFORMERS.
OUNA/D 4	DESCRIPTION	SHOWER		ADA SHOWER PAN	SHOWER ONLY, 1.75 GPM, SINGLE HANDLE, SINGLE FUNCTION	NA	1/2"	NA	1/2"	2"	2"	PROVIDE WITH ADA COMPLAINT GRAB BARS. HORIZONTAL AND VERTICAL
SHWR-1	MANUFACTURER	BESTBATH		ADA TRANSFER SHOWER PAN-ONE PIECE 40X38-FRONT TRENCH DRAIN	MOAN MODEL # T2262EP CIA SHROME POSI-TEMP SHOWER							GRAB BARS. PROVIDE MOAN UNIVERSAL ROUGH IN VALVE WITH SHOWER TRIM.
LB-1	DESCRIPTION	LAUNDRY BOX	ABS	FIRE RATED BOX, 1/2" SUPPLY W/ ARRESTERS, 2" DRAIN	NA	NA	1/2"	NA	1/2"	2"	1-1/2"	PROVIDE SECONDARY FUNNEL DRAIN FOR MECHANICAL CONDENSATE
LD-1	MANUFACTURER	SIOUX CHIEF		696R SERIES								PIPING. REFER TO PLAN FOR CONDENSATE DISCHARGE.
FD-1	DESCRIPTION	FLOOR DRAIN	CAST	6" SQUARE STRAINER, CAST IRON, ADJUSTABLE, NO-HUB	NA	NA	NA	NA	NA	4"	NA	BATHROOM FLOOR DRIANS TO HAVE TRAP PRIMER DEVICE AND SUPPLY INE TO FLOOR DRAINS. VEIRFY LOCATION OF TRAP PRIMER DEVICE IN
FD-1	MANUFACTURER	WATTS		FD-100-M								FIELD.
CO-1	DESCRIPTION	FLOOR CLEANOUT	CAST	5" SQUARE STRAINER, CAST IRON, NO-HUB	NA	NA	NA	NA	NA	4"	NA	INSTALL STRAINER FLUSH WITH FINSIHED FLOOR.
CO-1	MANUFACTURER	WATTS		CO-1200-S								INSTALL STRAINLINT LOSIT WITH INSHILL T LOOK.
WCO-1	DESCRIPTION	WALL CLEANOUT	STAINLESS STEEL	S.S. ACESS COVER	NA	NA	NA	NA	NA	3"	NA	COORDINATE WALL CLEAN TYPE WITH SANIATRY PIPE FITTINGS.
4400- 1	MANUFACTURER	WATTS		CO-590-RD								OCCUPATE WALL CLEAN THE WITH CANALITY FIFE THE HINGS.

					WATER HEATE	R SCHEDULE			
UNIT TAG	MANUFACTURER	MODEL	STORAGE CAPACITY	INLET TEMPERTURE	OUTLET TEMPERTURE	INPUT	CONNECTION	DIMENSIONS	KEY NOTES
DWH -1	LOCHINVAR	PVN05050 200	50 GAL	40 DEG. F	140 DEG. F.	50,000 BTU/HR	3/4" CW, 3/4" HW, 1/2" GAS		1, 2
NOTES:	,								,
1. WATEF	R HEATER TO MATCH	EXISTING.							
2. PROVII	DE 2X4 WOOD BASE \	N/ 3/4" PLY WOC	D AND PAINT T	O MATCH EXISTI	NG. +/- 3' SQ. BASE				
3. PROVII	DE WATER HEATER D	RAIN PAN. PIPE	OUTLET TO NE	AREST FLOOR DE	RAIN. PIPE T&P VALVI	E DOWN TO DRAIN PAN.			
4. PIPE P	OWER VENT PIPE TH	ROUGH ROOF.							
5. PROVII	DE THERMAL EXPANS	SION TANK. AMTF	ROL "ST-12," 4.4	GALLON TANK, 3	B/4" CONNECTION				

1. FIXTURES ARE BASIS OF DESIGN. FINAL FIXTURES SELECTION BY OWNER. CONTRACTOR MAY SUBMIT EQUAL FOR APPROVAL.

ERVICE	PIPE	SIZE
	< 1-1/2"	> 1-1/2"
OMESTIC COLD WATER	1"	1-1/2"
OMESTIC HOT WATER /R)	1"	2"
TORM	1"	2"
ANITARY / VENT	1"	1"

VALVE SCHEDULE											
VALVE	SERVICE	TYPE	NOTES								
BV-1	HOT WATER RETURN BALANCING VALVE	B&G CIRCUIT SOLVER	SYSTEM TO BE BALANCED POST INSTALL								
NOTES: E VALVES.	NTIRE SYSTEM TO BE RE	EBALENCED, NEW	AND EXISTING BALANCING								



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Client: EMPIRE STATE DEVELOPEMNT

oject: LONGSHED
INTERIOR
RENNOVATIONS

Project Address: CANAL SIDE
44 PRIME STREET
BUFFALO, NY 14202

Drawing History: <u># Date Description</u>

Project Status: NOT FOR


CONSTRUCTION

Date: MAY 16 ect Number: 23007

Sheet Title: SYMBOLS AND LEGENDS

et Number:

P001

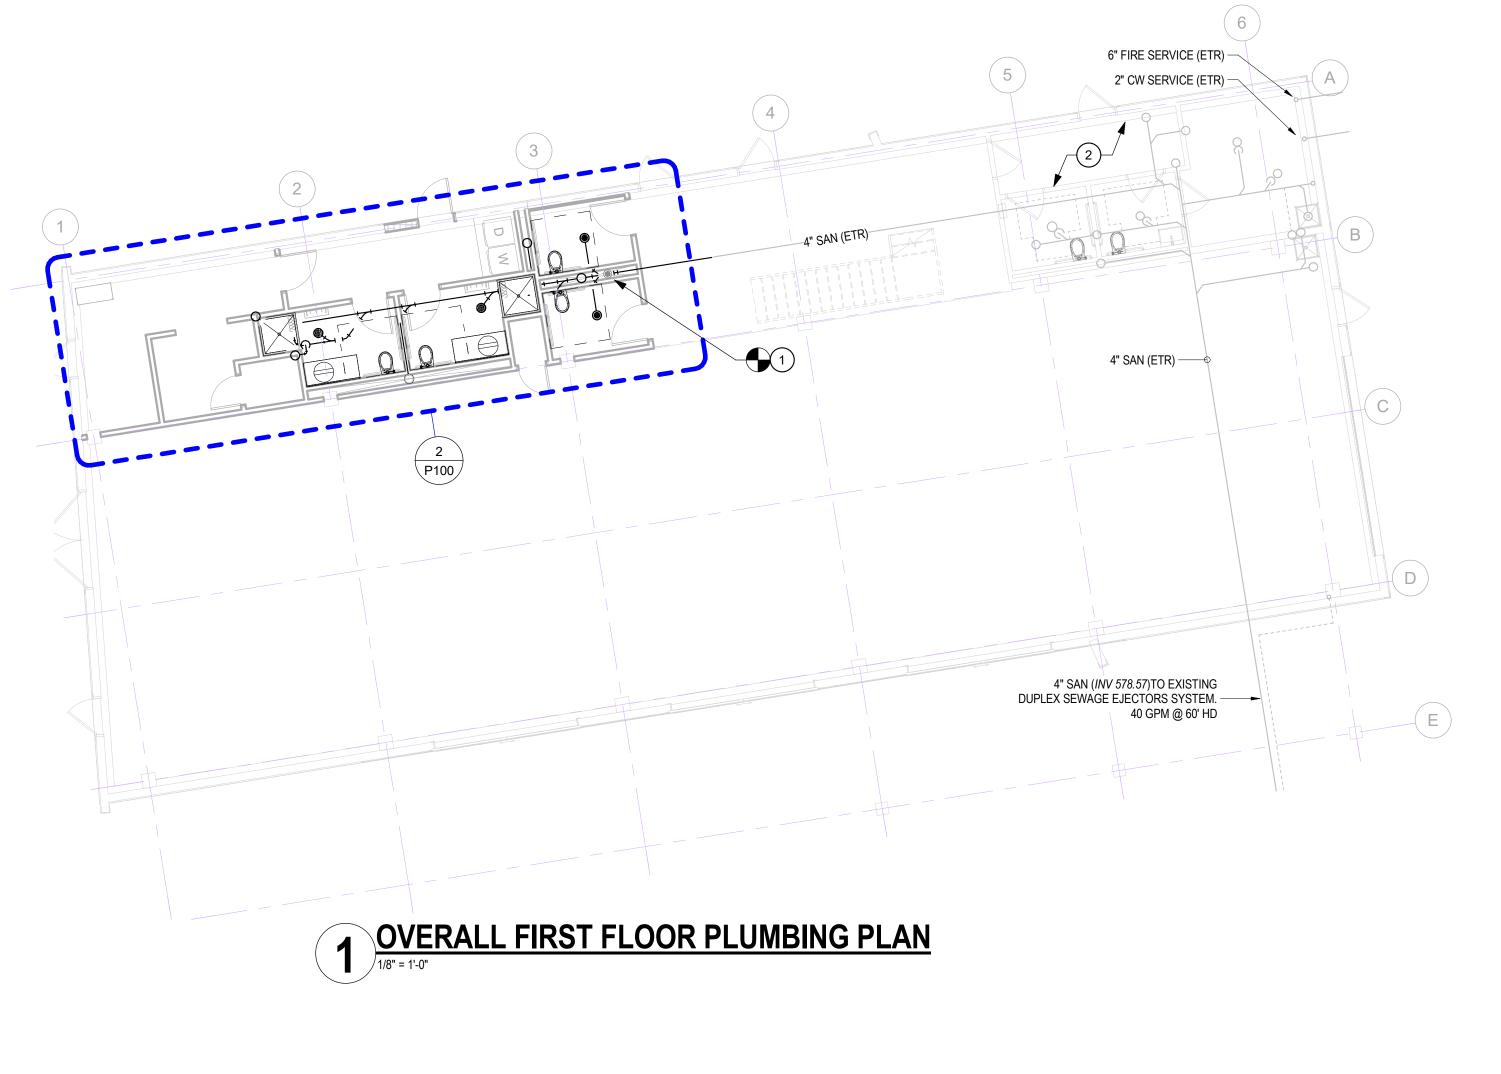

PLUMBING DRAWING NOTES:

REMOVE EXISTING FLOOR CLEAN OUT AND EXTEND SANITARY SEWER FOR NEW PLUMBING

FIXTURES.
PLUMBING FIXTURES ARE EXISTING TO REMAIN.

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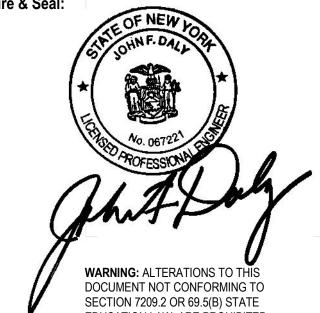
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DEVELOPEMNT

Project: LONGSHED INTERIOR RENNOVATIONS

Client: EMPIRE STATE

Project Address: CANAL SIDE
44 PRIME STREET
BUFFALO, NY 14202

Drawing History: # Date Description


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Sheet Title: UNDERSLAB


PLUMBING PLAN

Sheet Number: P100



4" SAN (ETR) INV 579.20'

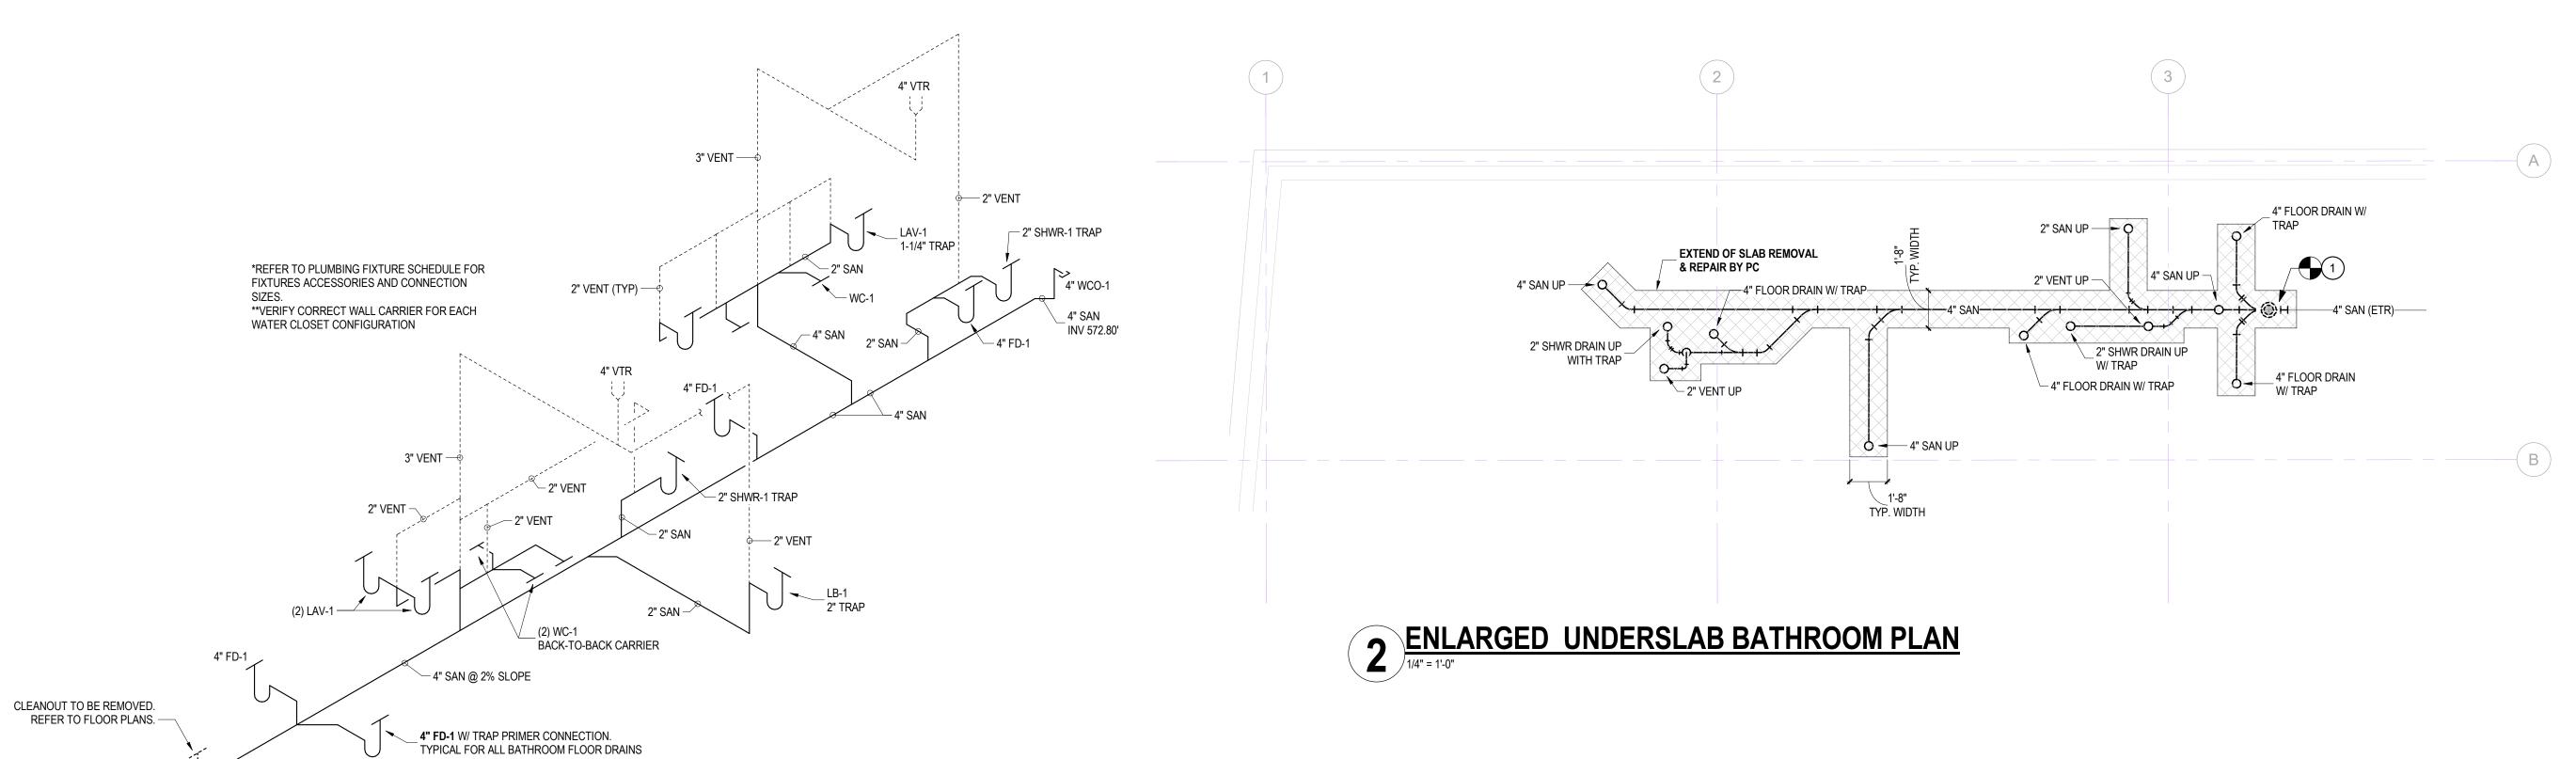4 SANIATRY ISOMETRIC DETAIL
NOT TO SCALE

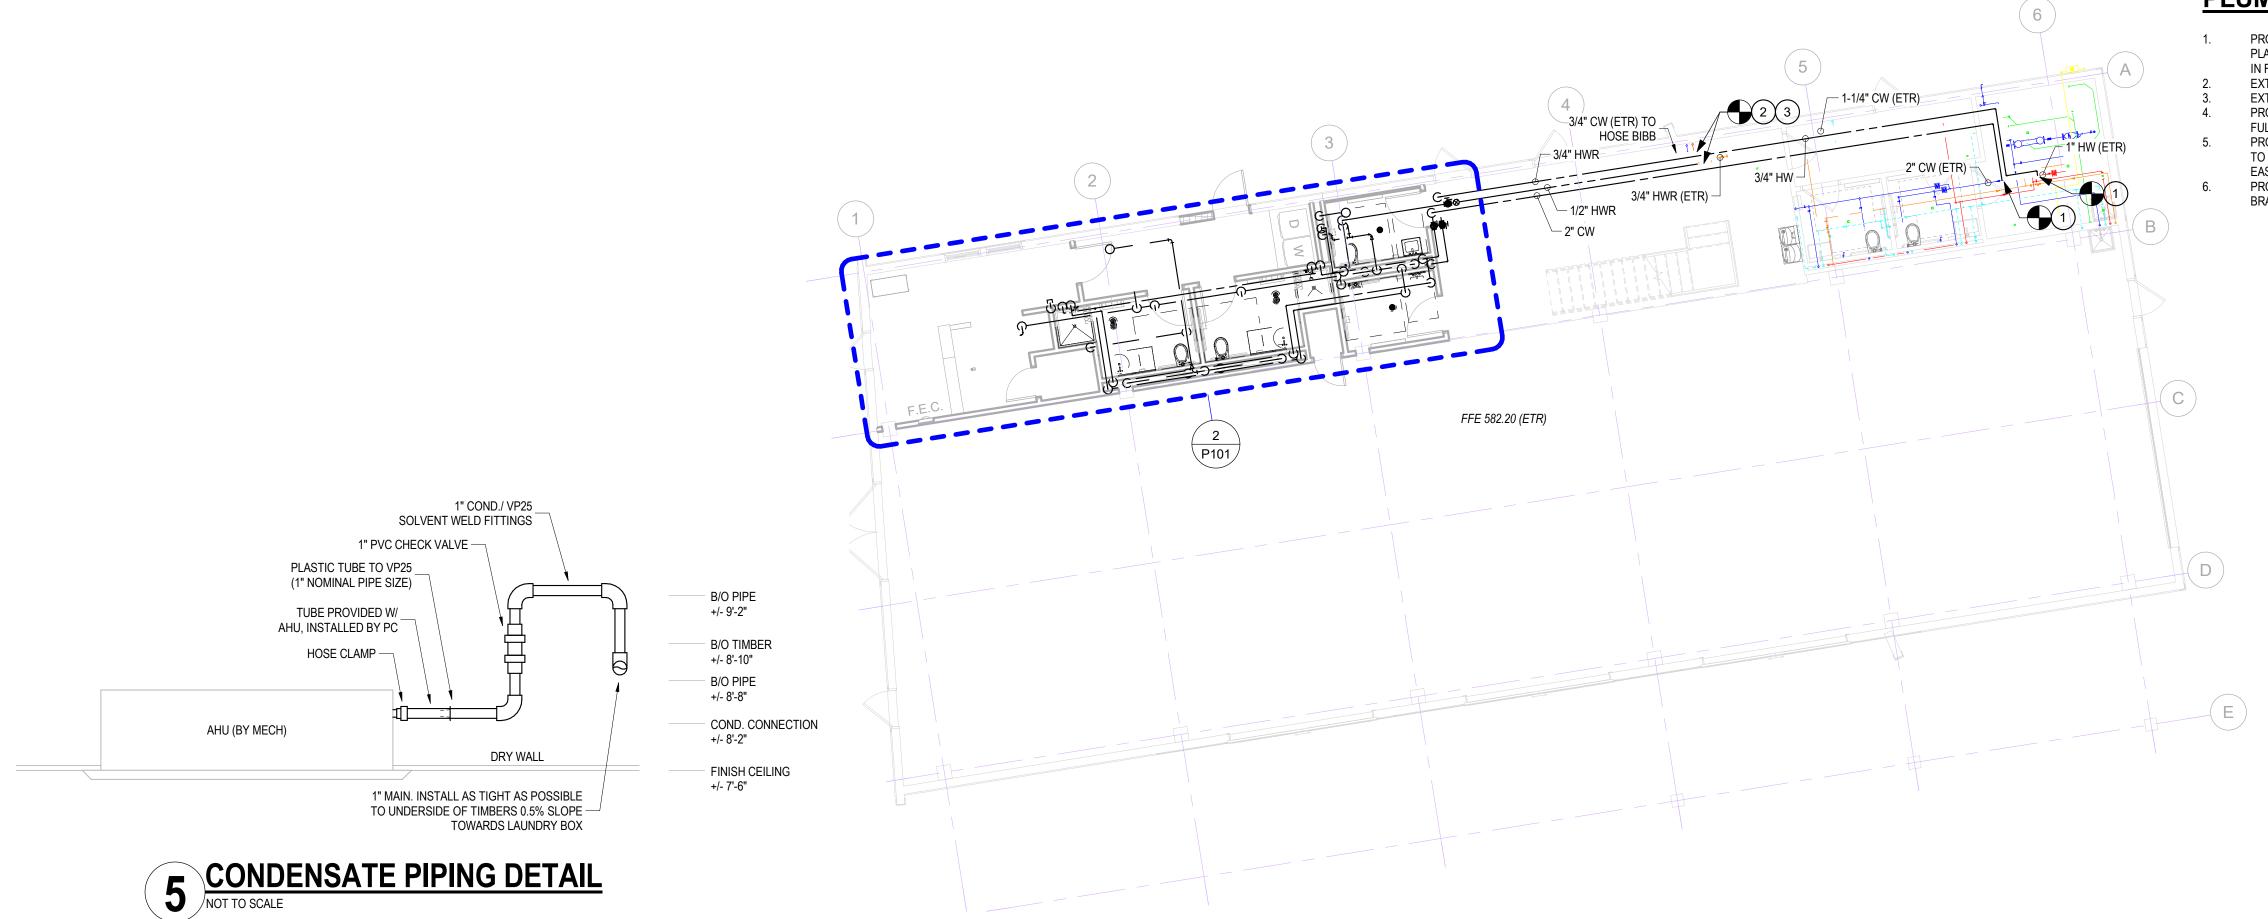

PLUMBING DRAWINGNOTES:

- PROVIDE NEW 2" COLD WATER BRANCH FOR NEW PLUMBING FIXTURES AS INDICATED ON THE PLANS. TIE INTO EXISTING 2" COLD WATER IN MECHANICAL ROOM. VERIFY POINT OF CONNECTION
- EXTEND 1" HOT WATER BRANCH FOR NEW PLUMBING FIXTURES. EXTEND 1/2" HOT WATER RECIRC. BRANCH.
- PROVIDE NEW B&G CIRCUIT SETTER WITH A SET POINT OF 110 DEG F AND FULL SIZE LEAD FREE FULL PORT BALL VALVE.
- TO THE NEW BATHROOM LAYOUTS. VALVES TO BE INSTALLED IN CEILING. ORIENT VALVES FOR
- EASY MAINTENANCE AND OPERATION. PROVIDE FULL SIZE, LEAD FREE, FULL PORT SHUTOFF VALVE BETWEEN HOT WATER AND RECIRC. BRANCHES. VALVE TO BE NORMALLY CLOSED.

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INTERIOR

RENNOVATIONS

Project Address:

CANAL SIDE 44 PRIME STREET BUFFALO, NY 14202


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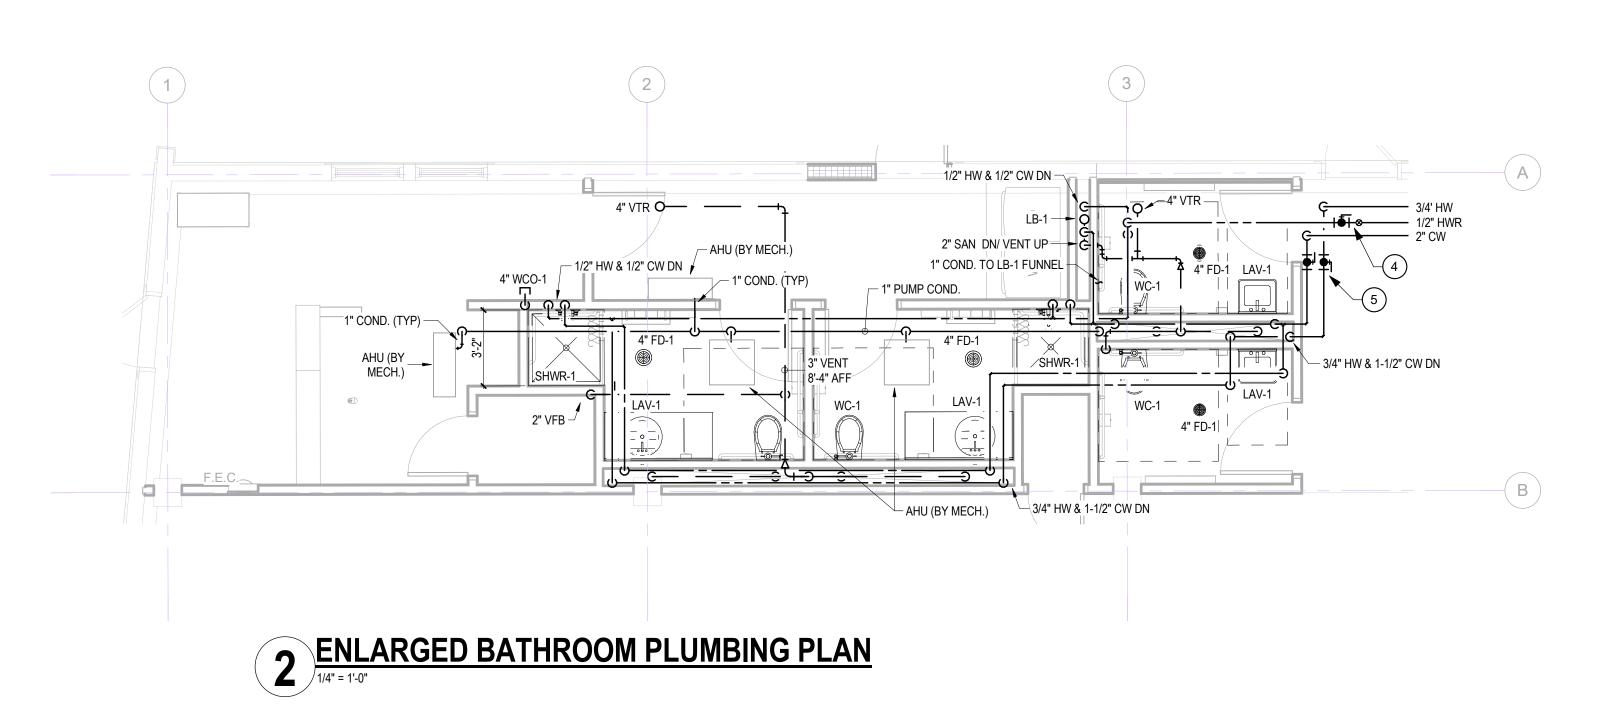
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Sheet Title: FIRST FLOOR **PLUMBING PLAN**


Sheet Number: P101

1 OVERALL FIRST FLOOR PLUMBING PLAN
1/8" = 1'-0"



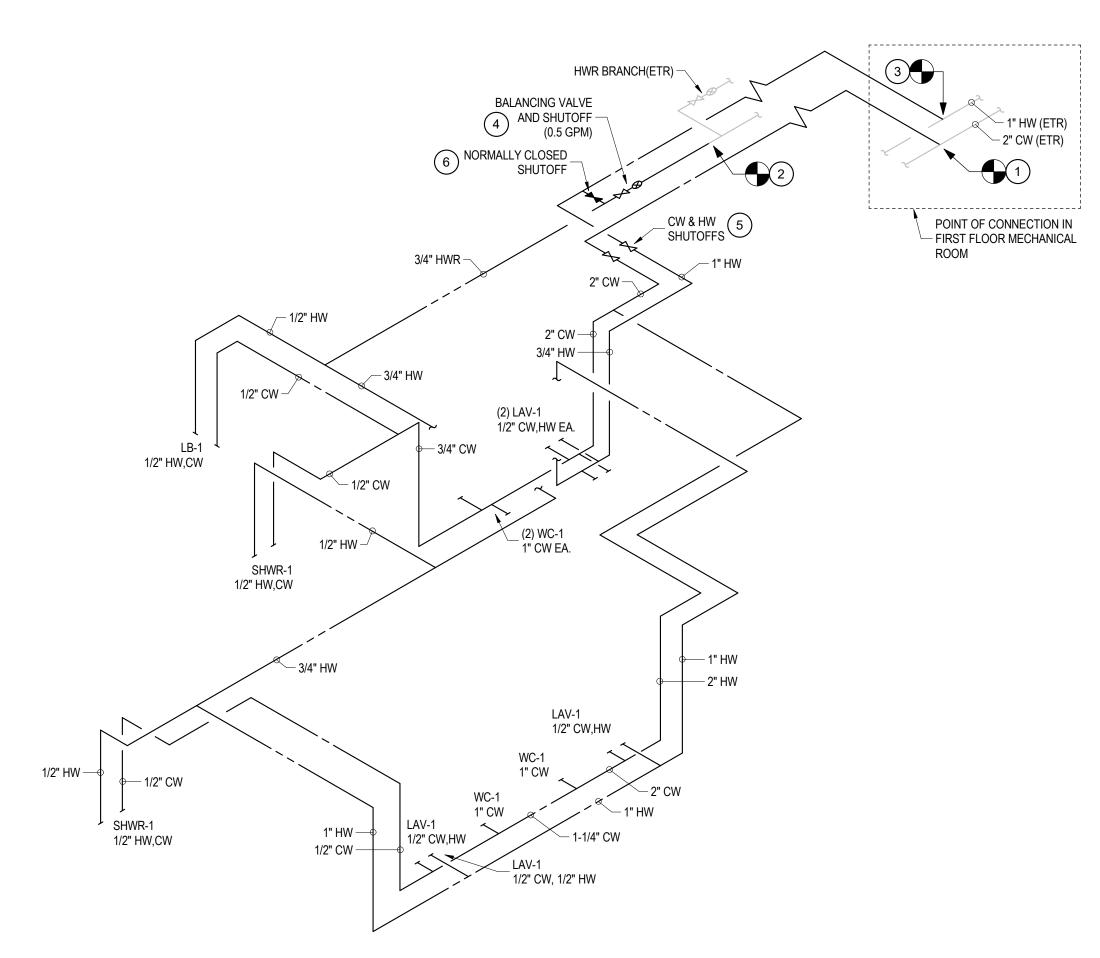

3 CW, HW, & HWR ISOMETRIC DETAIL
NOT TO SCALE

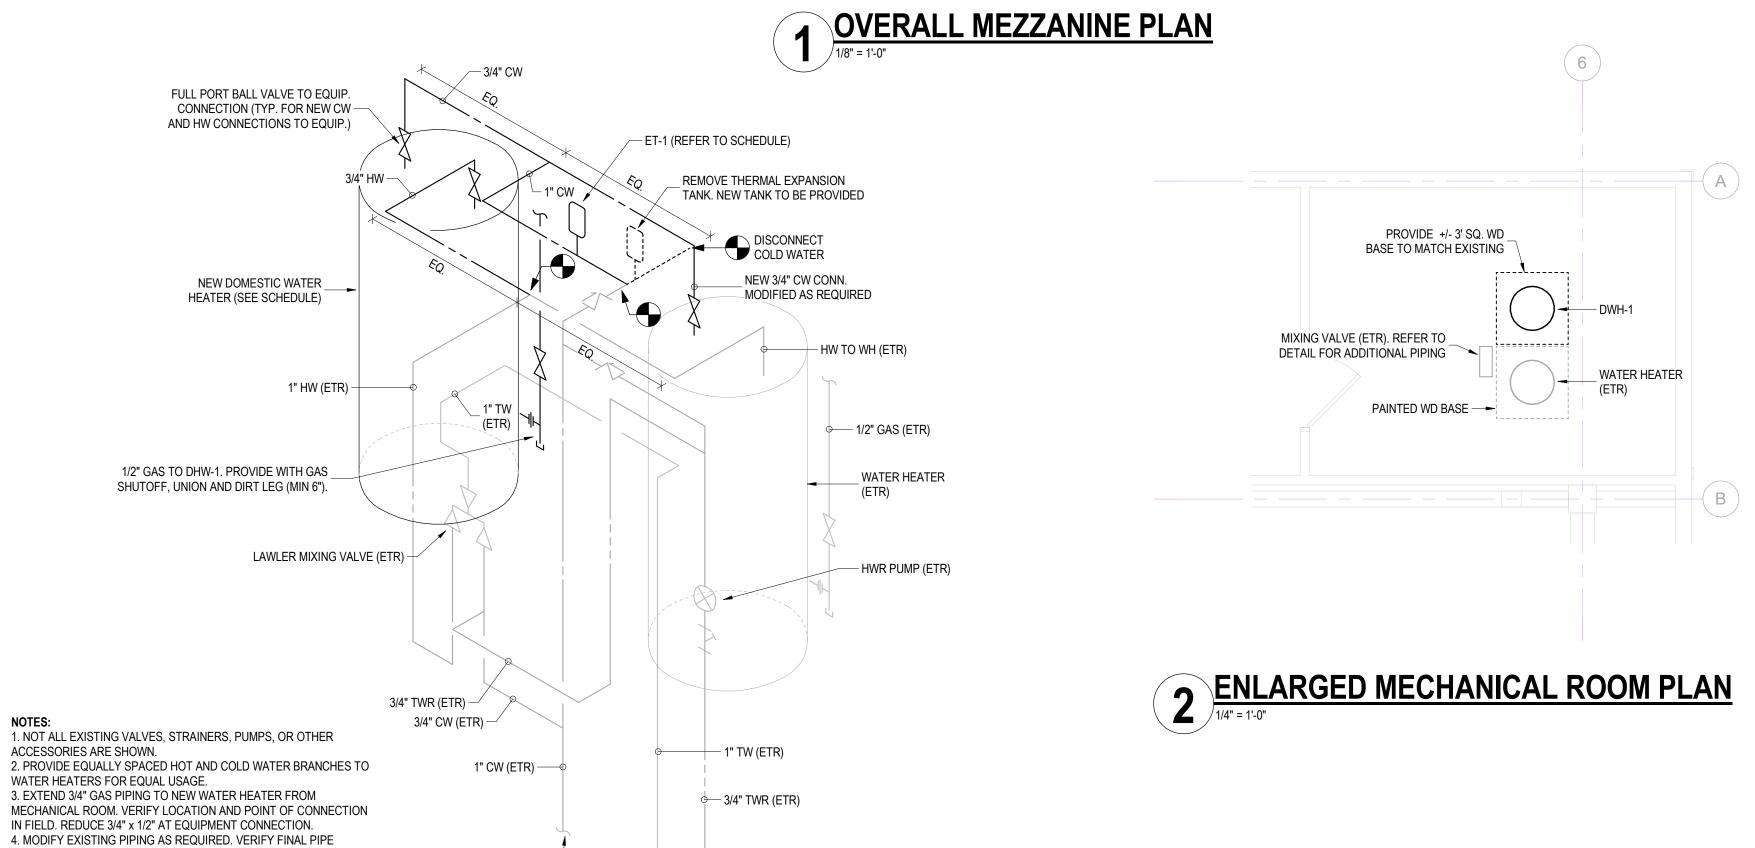

PLUMBING PLAN

Sheet Number: P102

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> Client: EMPIRE STATE DEVELOPEMNT

> > LONGSHED INTERIOR RENNOVATIONS

Project Address: CANAL SIDE
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BUFFALO, NY 14202

Drawing History: # Date Description

Project Status: NOT FOR CONSTRUCTION

MAY 16, 2023

Project Number: 23007 Sheet Title: MEZZANINE


NOTES:

FITTINGS, ROUTINGS, AND LOCATION IN FIELD.


CW, TW, & HWR DN TO CEILING _ OF FLOOR BELOW (SEE PLANS)

3 WATER HEATER PIPING DETAIL
NOT TO SCALE

FIF	RE PROTEC	CTION E	QUIF	MENT SCHEDULE
TAG	DESCRIPTION	MANUFACTURER	MODEL	REMARKS / ACCESSORIES
•	PENDENT HEADS	VIKING	VK1021	STANDARD RESPONSE, K=5.6, STANDARD ORIFICE, 1/2" NPT ORDINARY TEMPERATURE.
0	UPRIGHT HEADS	VIKING	VK1001	STANDARD RESPONSE, K=5.6, STANDARD ORIFICE, 1/2" NPT

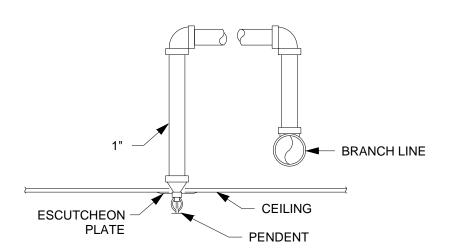

TYP. PENDENT HEAD DETAIL NTS

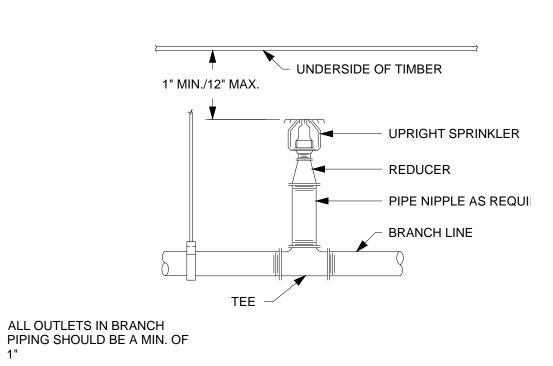

TYP. UPRIGHT HEAD DETAIL

FIRE PROTECTION NOTES: **(*)**

DEMO SPRINKLER PIPE UP TO POINT INDICATED.
 REMOVE SPRINKLER HEADS. ONCE HEADS ARE REMOVED, THEY MUST NOT BE REUSED.
 PAINT ALL EXPOSED SPRINKLER PIPING TO MATCH EXISTING CONDITIONS

GENERAL NOTES:

- WHERE SPRINKLER OR PIPING IS INDICATED TO BE PROVIDED, PROVIDE SPRINKLER, PIPING, AND ALL ASSOCIATED ACCESSORIES, INCLUDING HANGERS, ESCUTCHEONS, ETC.
 WHERE INSTALLED IN A CEILING GRID, SPRINKLER SHALL BE LOCATED IN THE CENTER OF THE
- 2'X2' CEILING TILE OR IN THE CENTER OF A 2'X2' HALF OF THE 2'X4' CEILING TILE.


 3. ALL PIPING, EQUIPMENT, AND ALL ACCESSORIES IN ALL AREAS, ARE TO BE INSTALLED TIGHT TO THE STRUCTURE TO ALLOW THE GREATEST FLOOR TO CEILING CLEARANCE POSSIBLE (VERIFY EXACT ROUTING IN FIELD).

 4. SHILT OF RIPING AS APPROPRIATE TO REPEORM WORK, NOTICY OWNER'S REPRESENTATIVE.
- 4. SHUT OFF PIPING AS APPROPRIATE TO PERFORM WORK. NOTIFY OWNER'S REPRESENTATIVE PRIOR TO TURNING OFF ANY SERVICES.
- PROVIDE FIRESTOPPING AT ALL PIPE PENETRATIONS THROUGH ALL FIRE RATED ASSEMBLIES.
 WHERE FLOOR PENETRATIONS ARE REQUIRED FOR SPRINKLER PIPING INSTALLATION, CUT AND REMOVE FLOOR AS NECESSARY. PATCH AND REPAIR FLOOR TO MATCH EXISTING FINISH.
 PROVIDE ALL TESTING AND ADJUSTING ACCORDING TO CODE AND TO SPECIFICATIONS.
 LABEL ALL PIPING, VALVES, EQUIPMENT, SPECIALTIES, ETC. ACCORDING CODE AND TO
- SPECIFICATIONS.

 9. ALL VALVES OR OTHER EQUIPMENT REQUIRING FUTURE SERVICE/MAINTENANCE ARE TO BE LOCATED IN ACCESSIBLE AREAS.
- COORDINATE SPRINKLER INSTALLATION WITH ALL OTHER TRADES, INCLUDING OTHER PIPING, DUCTWORK, DIFFUSERS, LIGHTS, AND FIRE ALARM SYSTEM, AS WELL AS THE EXISTING STRUCTURE.
- 11. PROVIDE ALL FIRE PROTECTION SPRINKLER PIPING AND ALL ASSOCIATED ACCESSORIES AS NECESSARY FOR FULLY FUNCTIONAL AND COMPLIANT INSTALLATION.
- NECESSARY FOR FULLY FUNCTIONAL AND COMPLIANT INSTALLATION.

 12. INSTALL ALL MATERIALS AND EQUIPMENT ACCORDING TO MANUFACTURERS INSTRUCTIONS AND RECOMMENDATIONS AND ACCORDING TO CODE.
- THE SPRINKLER SYSTEM SHALL BE INSTALLED IN FULL CONFORMANCE WITH NFPA 13 AS WELL AS THE REQUIREMENTS OF ALL APPLICABLE CODES AND AUTHORITIES HAVING JURISDICTION.
 CONTRACTOR TO SUBMIT HYDRAULIC CALCULATIONS WITH A DESIGNED SPRINKLER HEAD LAYOUT AND PIPING SYSTEM FOR APPROVAL.

FIRE PROTECTION SYMBOL / ABBREVIATIONS LIST

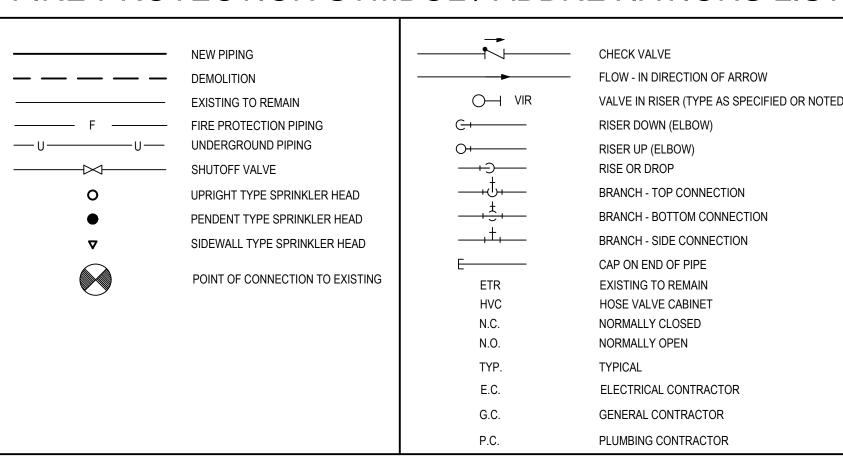



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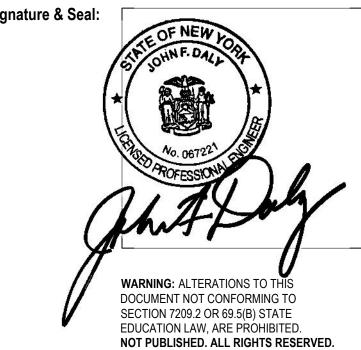
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Client: EMPIRE STATE DEVELOPEMNT

Project: LONGSHED INTERIOR

RENNOVATIONS

Project Address: CANAL SIDE
44 PRIME STREET
BUFFALO, NY 14202

Drawing History: # Date Description

Project Status: NOT FOR CONSTRUCTION

ate: MAY 16, 2023

Date: MAY 16, **Number:** 23007.0

Sheet Title: LONGSHED FIRE PROTECTION

PLAN

Sheet Number: FP100

2) SPOK (SER)


-2) SPOK (SER)


-2) SPOK (SER)

-2) SPOK (SER)

-3) SPOK (SER)

-4) PARTIAL FIRST FLOOR DEMO PLAN

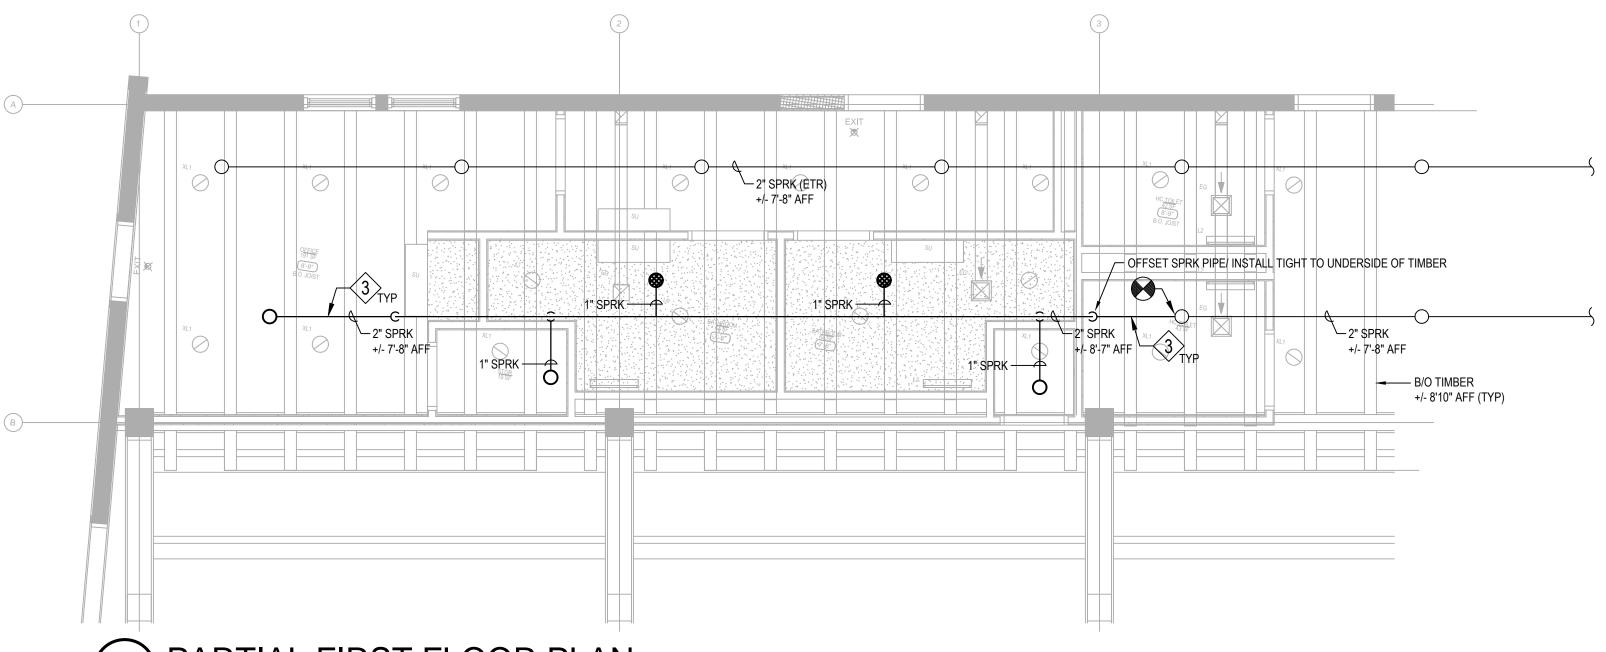

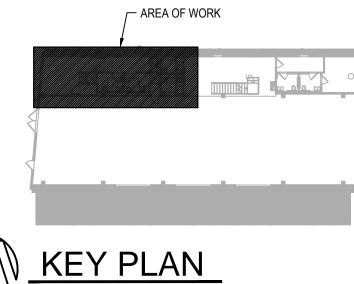

PARTIAL FIRST FLOOR PLAN

O'-1/4" = 1'-0"

ABBREVIATIONS:

AFF ABOVE FINISHED FLOOR A AMPERE

AIC ASYMMETRIC INTERRUPTING CAPACITY
AL ALUMINUM ATS AUTOMATIC TRANSFER SWITCH

AWG AMERICAN WIRE GAUGE BKR BREAKER

C CONDUIT
CLG CEILING
CKT CIRCUIT
CU COPPER

DIA DIAMETER DN DOWN

EA EACH EC ELECTRICAL CONTRACTOR
EF EXHAUST FAN

EMER EMERGENCY ETR EXISTING TO REMAIN

F FUSED FA FIRE ALARM

FAAP FIRE ALARM ANNUNCIATOR PANEL FACP FIRE ALARM CONTROL PANEL

GFCI GROUND FAULT CIRCUIT INTERRUPTER GFI GROUND FAULT INTERRUPTER

GND GROUND HP HORSEPOWER

K MULTIPLE OF 1000

JB JUNCTION BOX

LTG LIGHTING

LV LOW VOLTAGE MAX MAXIMUM MCB MAIN CIRCUIT BREAKER

MDP MAIN DISTRIBUTION PANEL MIN MINIMUM MTG HT MOUNTING HEIGHT

NL NIGHT LIGHT NEC NATIONAL ELECTRICAL CODE

NF NON-FUSED NTS NOT TO SCALE

OC OVER-COUNTER - EC TO VERIFY HEIGHT OF COUNTER TOP OCP OVERCURRENT PROTECTION

POLE PH PHASE

PNL PANEL PRI PRIMARY

TVSS TRANSIENT VOLTAGE SURGE SUPPRESSION

UC UNDER-CABINET

V VOLT VERIFY IN FIELD VIF

W WATT WG WIREGUARD

WP WEATHERPROOF

XFMR TRANSFORMER

D	DISTRIBUTION / BRANCH WIRING								
SYMBOL	DESCRIPTION								
	PANELBOARD/LOAD CENTER - REFER TO PANELBOARD SCHEDULE								
2.4 LP-1 •G	HOMERUN TO PANELBOARD - ARROW HEADS INDICATE NUMBER OF POLES. TEXT ADJACENT TO ARROW HEADS INDICATES PANELBOARD AND CIRCUIT DESIGNATIONS. SLASHES INDICATE CURRENT CARRYING CONDUCTORS. SLASH WITH DOT INDICATES GROUNDING CONDUCTOR. SLASH WITH G INDICATES ISOLATED GROUND CONDUCTOR.								
-#	RACEWAY OR CABLE WITH CONDUCTORS AS NOTED								
—o	CONDUIT OR CABLE UP								
	CONDUIT OR CABLE DOWN								
T	TRANSFORMER								

	DEVICES
SYMBOL	DESCRIPTION
OS DT	WALL - SWITCH OCCUPANCY SENSOR SUBSCRIPTS DENOTE TYPE: PIR - PASSIVE INFRARED US - ULTRASONIC DT - DUAL-TECHNOLOGY
©S US	CEILING MOUNTED OCCUPANCY SENSOR SUBSCRIPTS DENOTE TYPE: PIR - PASSIVE INFRARED US - ULTRASONIC USC - ULTRASONIC CORRIDOR COVERAGE DT - DUAL-TECHNOLOGY
SP	SWITCH PACK FOR OCCUPANCY SENSORS
RC	ROOM LIGHTING CONTROLLER
\$	TOGGLE SWITCH SUBSCRIPTS DENOTE TYPE: 3 - THREE WAY SWITCH 4 - FOUR WAY SWITCH LV - LOW VOLTAGE SWITCH T - MOTOR-RATED SWITCH D - DIMMER CONTROL ROMAN NUMERALS INDICATE GANGED SWITCHES LETTERS (a,b,c) INDICATE SWITCH LEGS
Φ	DUPLEX RECEPTACLE - 125V, 20A SUBSCRIPTS DENOTE TYPE: GFI - GROUND FAULT CIRCUIT INTERRUPTER OC - OVER COUNTER TVSS - TRANSIENT VOLTAGE SURGE SUPPRESOR UC - UNDER COUNTER WP - WEATHER PROOF WHILE-IN-USE TR - TAMPER RESISTANT
\bigcirc	EQUIPMENT RECEPTACLE - REFER TO NOTE FOR CONFIGURATION
#	DOUBLE DUPLEX RECEPTACLE
Щ	SURFACE-MOUNTED DUPLEX RECEPTACLE
+	EQUIPMENT CONNECTION - DIRECT CONNECTION OR MATCH CORD AND CAP AS REQUIRED
	DISCONNECT SWITCH
J	JUNCTION BOX
∇	DATA OUTLET IN 4" SQUARE OUTLET BOX WITH 3/4" CONDUIT STUBBED TO ABOVE ACCESSIBLE CEILING
	TELCOM AND DATA OUTLETS IN 4" SQUARE OUTLET BOX WITH

	FIRE ALARM
SYMBOL	DESCRIPTION
FACP	FIRE ALARM CONTROL PANEL
FAAP	FIRE ALARM ANNUNCIATOR PANEL
F	MANUAL PULLSTATION
Œ	AUDIO/VISUAL NOTIFICATION DEVICE (HORN/STROBE)
FX	VISUAL NOTIFICATION DEVICE

	LIGHTING
SYMBOL	DESCRIPTION
	LIGHTING FIXTURE AND OUTLET BOX
\oslash	CEILING LIGHTING FIXTURE AND OUTLET BOX
\bigcirc	WALL-MOUNTED LIGHTING FIXTURE AND OUTLET BOX
EM	SHADING/EM DENOTES EMERGENCY FIXTURE - FIXTURE TO HAVE INTEGRAL BATTERY BACKUP
NL	SHADING/NL DENOTES NIGHT-LIGHT FIXTURE - FIXTURE TO BE UNSWITCHED
	EXIT SIGN - SOLID QUADRANT DENOTES DIRECTIONAL ARROWS AND LINE DENOTES PANELS/FACES
	EMERGENCY LIGHT WITH SELF DIAGNOSTICS AND 90 MINUTE BATTERY PACK

	GENERAL	
DEVICES	DESCRIPTION	
	HEAVY LINEWEIGHT DENOTES NEW DEVICE, E CONNECTION	EQUIPMENT, OR
	LIGHT LINEWEIGHT DENOTES EXISTING DEVICE CONNECTION TO REMAIN	CE, EQUIPMENT, OR
	BROKEN LIGHT LINEWEIGHT DENOTES EXIST CONNECTION TO BE REMOVED	ING DEVICE, EQUIPMENT, OR
П	ROMAN NUMERALS INDICATE NUMBER OF DE	VICES
DEVICES	MOUNTING HEI	MOUNTING HEIGHT
RECEPTA	CLES	18" AFF
EXTERIO	R RECEPTACLES	24" AFF
SWITCHE	S	44" AFF
DATA/TEL	COM OUTLETS	18" AFF
FIRE ALA	RM MANUAL PULLSTATIONS	44" AFF
FIRE ALA	RM VISUAL NOTIFICATION DEVICE	ENTIRE LENS BTW 80"-96" AFF
	G HEIGHTS OF DEVICES TO THE CENTER OF DEVICES NOTED	VICE AS INDICATED, UNLESS

CIRCUIT NUMBER FIXTURE TYPE D 8 CIRCUIT NUMBER FIXTURE TYPE
CIRCUIT NUMBER
FIXTURE TYPE
SWITCH LEG b EM/NL D PP-1/12 EMERGENCY/NIGHT
- LIGHT FIXTURE CIRCUIT NUMBER PANELBOARD
*TYPICAL OF NEARBY FIXTURES UNLESS OTHERWISE NOTED
CIRCUIT NUMBER — PP-1/12 CIRCUIT NUMBER PANELBOARD

	l	LUMINAIRE SC	HEDULE			
TYPE	DESCRIPTION	MANUFACTURER & CAT. No.	LAMP(S)	BALLAST/VOLT.	MOUNTING	NOTES
D1	6" LED RECESSED DOWNLIGHT WITH 0-10V DIMMING AND DAMP LOCATION RATING	HALO LIGHTING HC6-10-D010-HM6-0525- 835 OR APPROVED EQUAL	LED 3500K 1000 LUMENS 80 CRI	MULTIVOLT	RECESSED IN CEILING	-
U1	2' LED UNDERCABINET FIXTURE WITH DIRECT WIRE JUNCTION BOX, FROSTED LENS, ALUMINUM HOUSING, MIN. L70 OF 50,000 HOURS AND 5 YEAR WARRANTY	LITHONIA LIGHTING UCLD-24IN-30K-90CRI OR APPROVED EQUAL	LED 740 LUMENS 3000K, 90 CRI	120V	SURFACE MOUNTED	PROVIDE UCD-JB ACCESSORY
W1	2' LED LINEAR BATHROOM VANITY FIXTURE WITH 0-10V DIMMING DRIVER, FROSTED LENS, WET LOCATION RATING AND 5 YEAR WARRANTY	COOPER SHAPER 605-25-W-L3/835-UNV- ALP OR APPROVED EQUAL	LED 2000 LUMENS 3500K, 80 CRI	MULTIVOLT	SURFACE MOUNTED	
$\overline{\otimes}$	LED EXIT SIGN WITH UV-STABILIZED THERMOPLASTIC HOUSING, UNIVERSAL MOUNTING AND RED LETTERS WITH BACKUP BATTERY	LITHONIA LIGHTING LQM-S-W-3-R-120/277- EL-N-M6 OR APPROVED EQUAL	LED	MULTIVOLT	AS INDICATED ON DRAWINGS	PROVIDE FACES AND ARROWS AS INDICATED ON DRAWINGS
	LED EMERGENCY FIXTURE WITH (2) 3.3W LED LAMPS, SEALED NICKEL CADMIUM BATTERY WITH MINIMUM 90 MINUTE ILLUMINATION AND SELF DIAGNOSTICS	LITHONIA LIGHTING ELM4L OR APPROVED EQUAL	LED (2) 6.6W LED	MULTIVOLT WITH BATTERY PACK	WALL-MOUNTED	-



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Client: EMPIRE STATE DEVELOPMENT

Project: LONGSHED INTERIOR RENOVATIONS

Project Address: CANALSIDE
44 PRIME ST.
BUFFALO, NY 14202

Drawing History: # Date Description


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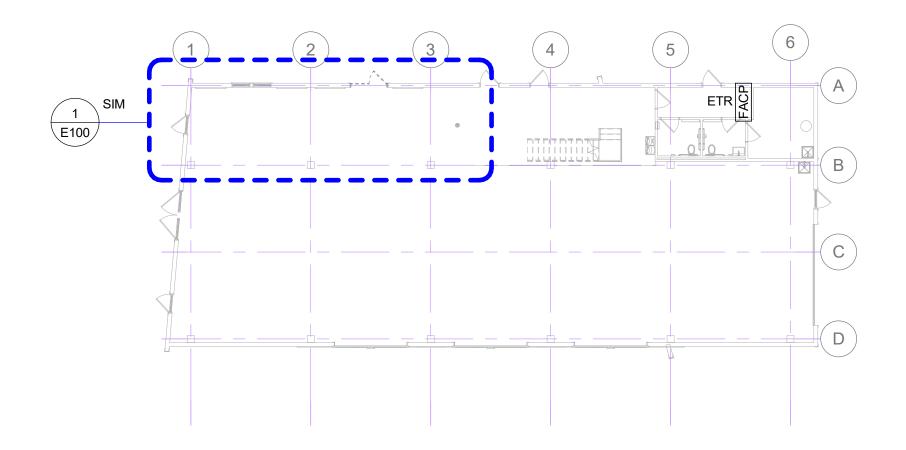
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Sheet Title: SYMBOL LEGEND, **DETAILS &**

SCHEDULES


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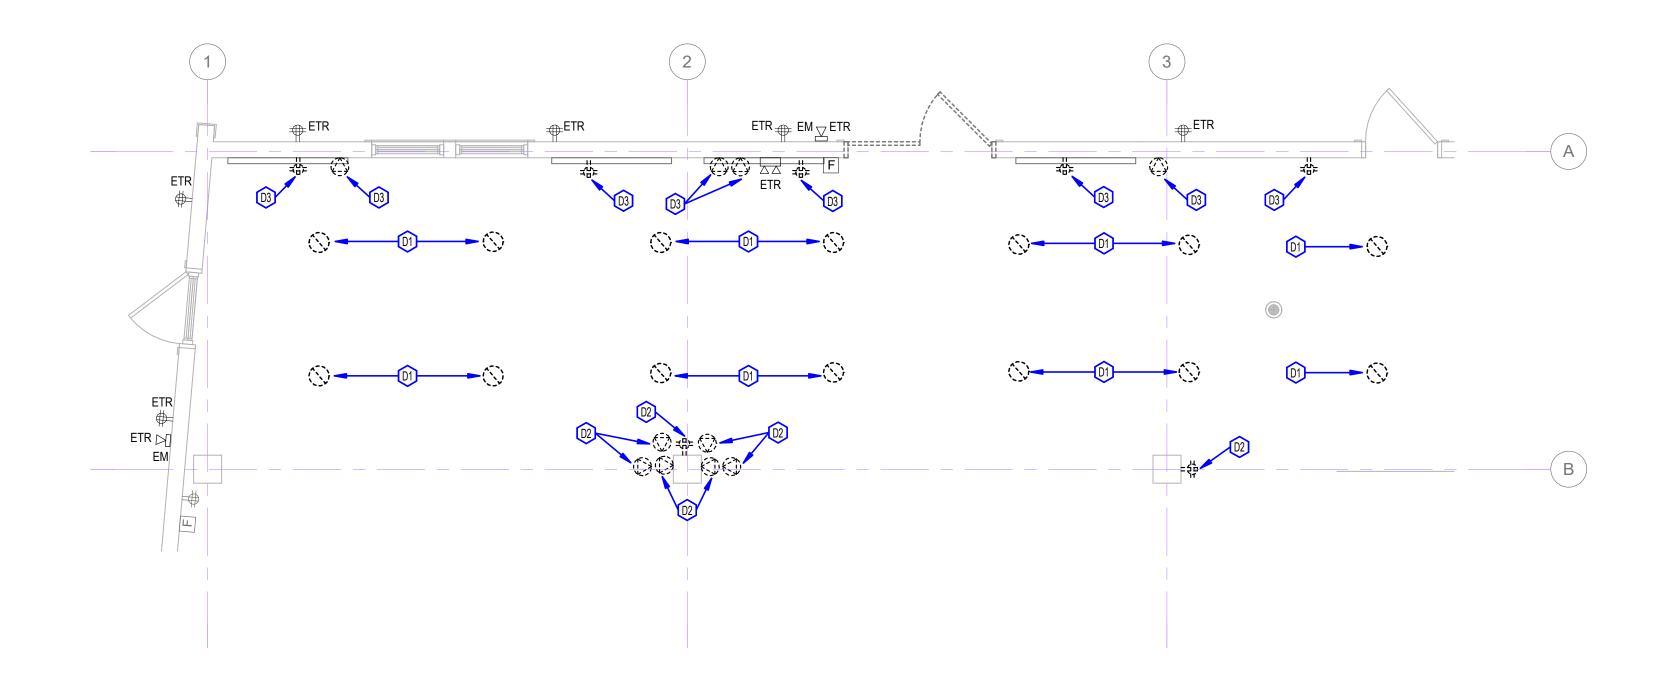


FIRST FLOOR PLAN

SCALE: 1/16" = 1'-0"

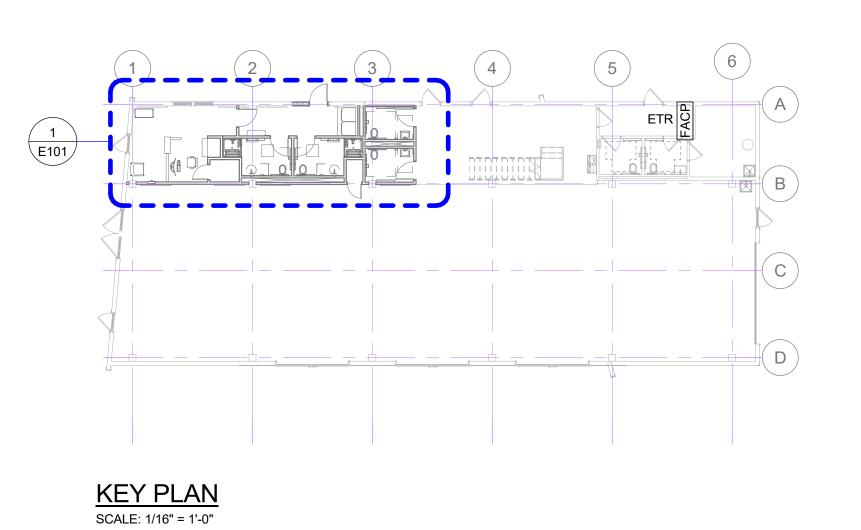

SECOND FLOOR PLAN SCALE: 1/16" = 1'-0"

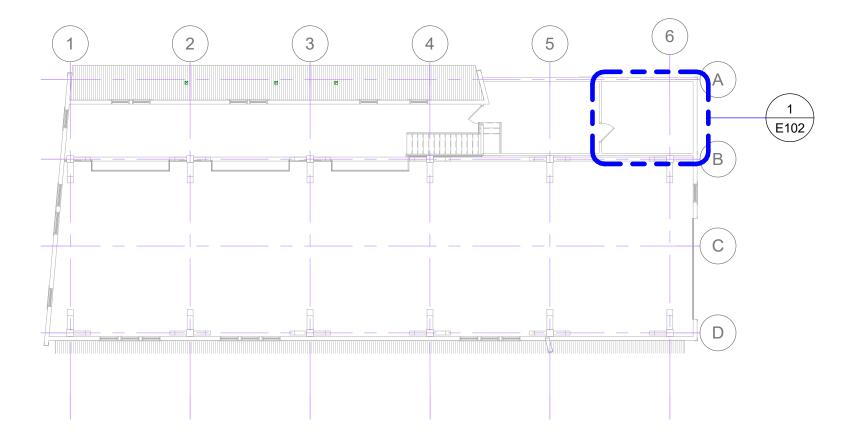



GENERAL ELECTRICAL DEMO NOTES:

- DEMOLITION DRAWINGS ARE INTENDED TO PROVIDE AN APPROXIMATE SCOPE OF DEMOLITION WORK, AND DO NOT INDICATE ALL DEVICES, BOXES, AND EQUIPMENT. THE CONTRACTOR SHALL MAINTAIN THE CONTINUITY OF DEVICES DOWNSTREAM
- OF THE SCHEDULED DEMOLITION.
- THE CONTRACTOR SHALL PERFORM ALL WORK TO THE 2017 EDITION OF THE NEC. THE CONTRACTOR SHALL COORDINATE ALL WORK BETWEEN TRADES AND SHALL
- REVIEW TRADE DRAWINGS FOR COORDINATION PURPOSES. THE CONTRACTOR SHALL PROVIDE TYPED, UPDATED PANELBOARD SCHEDULES INDICATING CHANGES MADE BY THIS PROJECT.
- THE CONTRACTOR IS RESPONSIBLE TO FIELD VERIFY EXISTING CONDITIONS.

ELECTRICAL DRAWING DEMO NOTES (#):

- DISCONNECT AND REMOVE EXISTING LIGHT FIXTURE FOR RELOCATION. MAINTAIN WIRING AND CONDUIT.
- DISCONNECT AND REMOVE COLUMN-MOUNTED RECEPTACLES FOR
- RELOCATION. MAINTAIN WIRING AND CONDUIT.
 DISCONNECT AND REMOVE RECEPTACLE. MAINTAIN WIRING AND CONDUIT FOR RELOCATION. PATCH AND REPAIR WALL TO MATCH
- EXISTING CONDITIONS.



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Client: EMPIRE STATE DEVELOPMENT

Project: LONGSHED INTERIOR RENOVATIONS

Project Address: CANALSIDE
44 PRIME ST.
BUFFALO, NY 14202

Drawing History: # Date Description

Project Status: NOT FOR


CONSTRUCTION

Sheet Title: ELECTRICAL

DEMOLITION PLAN

Sheet Number: **E100**



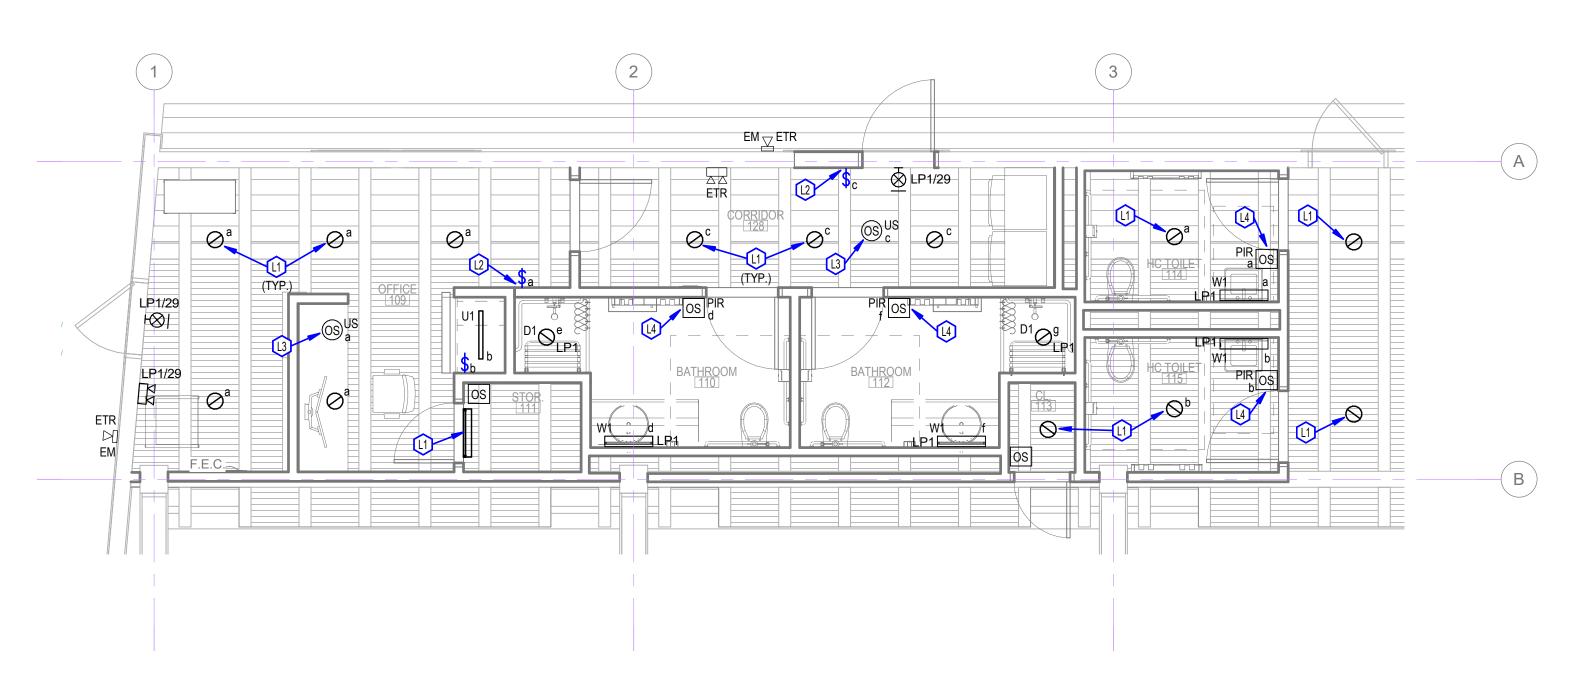

FIRST FLOOR LIGHTING PLAN

1/4" = 1'-0"

GENERAL ELECTRICAL NOTES:

- A. PROVIDE BRANCH CIRCUITING FOR ALL DEVICES SHOWN. BRANCH WIRING IS, IN GENERAL, NOT SHOWN WITH THE FOLLOWING UNDERSTANDING; THE CONTRACTOR SHALL "CIRCUIT UP" ALL DEVICES SHOWN IN THE MOST EFFECTIVE ROUTING, BASED ON CONSTRUCTION CONDITIONS AND/OR RESTRICTIONS.
- B. THE USE OF EXPOSED RACEWAYS IN FINISHED AREAS IS NOT ACCEPTABLE UNLESS ALL OTHER METHODS OF RACEWAY CONCEALMENT HAVE BEEN EXHAUSTED. ALL CONDUIT/WIRE/CABLING SHALL BE RUN WITHIN THE CEILING AND WALL SPACES.
- C. THE CONTRACTOR SHALL PERFORM ALL WORK TO THE 2017 EDITION OF THE NEC.

 THE CONTRACTOR SHALL COORDINATE ALL WORK BETWEEN TRADES AND SHALL
- REVIEW TRADE DRAWINGS FOR COORDINATION PURPOSES.

 E. UNLESS OTHERWISE NOTED, ALL BRANCH CIRCUIT WIRING SHALL BE #12 AWG
- F. CIRCUIT NUMBERS ON THIS DRAWING ARE FOR THE SOLE PURPOSE OF CLARIFICATION, AND ARE NOT INTENDED TO INDICATE POLE POSITION IN THE PANELBOARD. UNLESS OTHERWISE NOTED, THE CONTRACTOR SHALL CONNECT ALL DEVICES TO AVAILABLE CIRCUITS IN DESIGNATED PANELBOARDS. THE CONTRACTOR SHALL BALANCE ALL LOADS IN THE PANEL AND SHALL INDICATE THE CORRECT CIRCUIT DESIGNATIONS ON A TYPED PANELBOARD SCHEDULE AND ON "AS-BUILT" RECORD DRAWINGS.
- G. CONNECT NEW FIRE ALARM DEVICES TO EXISTING FIRE ALARM SYSTEM.

ELECTRICAL DRAWING NOTES (#):

- 1. EXTEND/REWORK THE EXISTING BRANCH CIRCUIT WIRING AND CONDUIT INSIDE WALL TO RELOCATED EQUIPMENT RECEPTACLE. RE-INSTALL RECEPTACLES AT 44" AFF. REPLACE ANY PORTIONS OF THE WIRING THAT MAY BE DAMAGED OR INADQUATE LENGTH.
- 2. EXTEND NEW BRANCH CIRCUIT WIRING IN 3/4" EMT CONDUIT FROM RECEPTACLES TO SPARE 1P20A BREAKER.
- 3. PROVIDE NEMA 14-30R RECEPTACLE FOR DRYER. EXTEND (3) #10 AWG CU THWN WIRES + (1) #10 CU GND IN 3/4" EMT CONDUIT FROM
- RECEPTACLE TO PANEL LP1 SECTION 2. PROVIDE NEW 2P30A BREAKER.

 4. PROVIDE DATA OUTLET WITH (2) RJ45 JACKS UNDER DESK. EXTEND (1) CAT-6 CABLE TO PHONE SYSTEM AND (1) CAT-6 CABLE TO INTERNET PATCH PANEL IN SECOND FLOOR MECH ROOM.

GENERAL LIGHTING NOTES:

- A. PROVIDE BRANCH CIRCUITING FOR ALL DEVICES SHOWN. BRANCH WIRING IS, IN GENERAL, NOT SHOWN WITH THE FOLLOWING UNDERSTANDING; THE CONTRACTOR SHALL "CIRCUIT UP" ALL DEVICES SHOWN IN THE MOST EFFECTIVE ROUTING, BASED ON CONSTRUCTION CONDITIONS AND/OR RESTRICTIONS.
- B. THE CONTRACTOR SHALL PERFORM ALL WORK TO THE 2017 EDITION OF THE NEC.
 C. THE CONTRACTOR SHALL COORDINATE ALL WORK BETWEEN TRADES AND SHALL
- REVIEW TRADE DRAWINGS FOR COORDINATION PURPOSES.

 D. REVIEW ARCHITECTURAL CEILING PLAN FOR EXACT FIXTURE LAYOUT AND LOCATIONS.
- E. UNLESS OTHERWISE NOTED, ALL BRANCH CIRCUIT WIRING SHALL BE #12 AWG MINIMUM.
 F. CIRCUIT NUMBERS ON THIS DRAWING ARE FOR THE SOLE PURPOSE OF CLARIFICATION, AND ARE NOT INTENDED TO INDICATE POLE POSITION IN THE PANELBOARD. UNLESS
- OTHERWISE NOTED, THE CONTRACTOR SHALL CONNECT ALL DEVICES TO AVAILABLE CIRCUITS IN DESIGNATED PANELBOARDS. THE CONTRACTOR SHALL BALANCE ALL LOADS IN THE PANEL AND SHALL INDICATE THE CORRECT CIRCUIT DESIGNATIONS ON A
- TYPED PANELBOARD SCHEDULE AND ON "AS-BUILT" RECORD DRAWINGS.

 G. UNLESS OTHERWISE NOTED, ALL EMERGENCY LIGHTS SHALL BE CONNECTED TO UNSWITCHED PORTION OF GENERAL LIGHTING CIRCUITS.
- H. ALL LIGHTING CONTROLS SHALL BE PROGRAMMED PER 2020 NYS ENERGY CONSERVATION CODE.

LIGHTING DRAWING NOTES (#):

- EXTEND/REWORK THE EXISTING BRANCH CIRCUIT WIRING AND CONDUIT TO RELOCATED LIGHT FIXTURE. REPLACE ANY PORTIONS OF THE WIRING AND CONDUIT THAT MAY BE DAMAGED OR INADEQUATE LENGTH.
- 2. CONNECT NEW LIGHT SWITCH TO EXISTING LIGHTING ZONE. EXTEND (1) CAT-5E CABLE IN 3/4" EMT CONDUIT TO EXISTING ROOM CONTROLLER IN SECOND FLOOR ELECTRICAL ROOM.
- 3. PROVIDE NEW CEILING-MOUNTED OCCUPANCY SENSOR. EXTEND (1)
 CAT-5E CABLE IN 3/4" EMT CONDUIT TO EXISTING ROOM CONTROLLER IN
 SECOND FLOOR ELECTRICAL ROOM.
- CONNECT WALL-MOUNTED OCCUPANCY SENSOR TO RESTROOM LIGHTS AND EXHAUST FAN.



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Client: EMPIRE STATE DEVELOPMENT

ct: LONGSHED INTERIOR RENOVATIONS

Project Address:

CANALSIDE 44 PRIME ST. BUFFALO, NY 14202

Drawing History: # Date Description

Project Status: NOT FOR CONSTRUCTION

OONOTINO

Date: MAY 16, 2023 **Project Number:** 23007.00

Sheet Title: FIRST FLOOR
POWER AND
LIGHTING PLANS

Sheet Number: E101

GENERAL ELECTRICAL NOTES:

MINIMUM.

PROVIDE BRANCH CIRCUITING FOR ALL DEVICES SHOWN. BRANCH WIRING IS, IN GENERAL, NOT SHOWN WITH THE FOLLOWING UNDERSTANDING; THE CONTRACTOR SHALL "CIRCUIT UP" ALL DEVICES SHOWN IN THE MOST EFFECTIVE

ROUTING, BASED ON CONSTRUCTION CONDITIONS AND/OR RESTRICTIONS.


THE USE OF EXPOSED RACEWAYS IN FINISHED AREAS IS NOT ACCEPTABLE UNLESS ALL OTHER METHODS OF RACEWAY CONCEALMENT HAVE BEEN EXHAUSTED. ALL CONDUIT/WIRE/CABLING SHALL BE RUN WITHIN THE CEILING AND WALL SPACES.

UNLESS OTHERWISE NOTED, ALL BRANCH CIRCUIT WIRING SHALL BE #12 AWG

- THE CONTRACTOR SHALL PERFORM ALL WORK TO THE 2017 EDITION OF THE NEC.
- THE CONTRACTOR SHALL COORDINATE ALL WORK BETWEEN TRADES AND SHALL REVIEW TRADE DRAWINGS FOR COORDINATION PURPOSES.
- CIRCUIT NUMBERS ON THIS DRAWING ARE FOR THE SOLE PURPOSE OF CLARIFICATION, AND ARE NOT INTENDED TO INDICATE POLE POSITION IN THE PANELBOARD. UNLESS OTHERWISE NOTED, THE CONTRACTOR SHALL CONNECT ALL DEVICES TO AVAILABLE CIRCUITS IN DESIGNATED PANELBOARDS. THE CONTRACTOR SHALL BALANCE ALL LOADS IN THE PANEL AND SHALL INDICATE THE CORRECT CIRCUIT DESIGNATIONS ON A TYPED PANELBOARD SCHEDULE AND ON "AS-BUILT" RECORD DRAWINGS.
- CONNECT NEW FIRE ALARM DEVICES TO EXISTING FIRE ALARM SYSTEM.

ELECTRICAL DRAWING NOTES (#):


REPLACE (3) 1P20A BREAKERS WITH (1) 3P100A BREAKER. EXTEND NEW FEEDERS AND CONDUIT TO PANEL LP3 UTILIZING EXISTING WIRING GUTTER. EXTEND RELOCATED CIRCUITS TO PANEL LP1 SECTION 2.

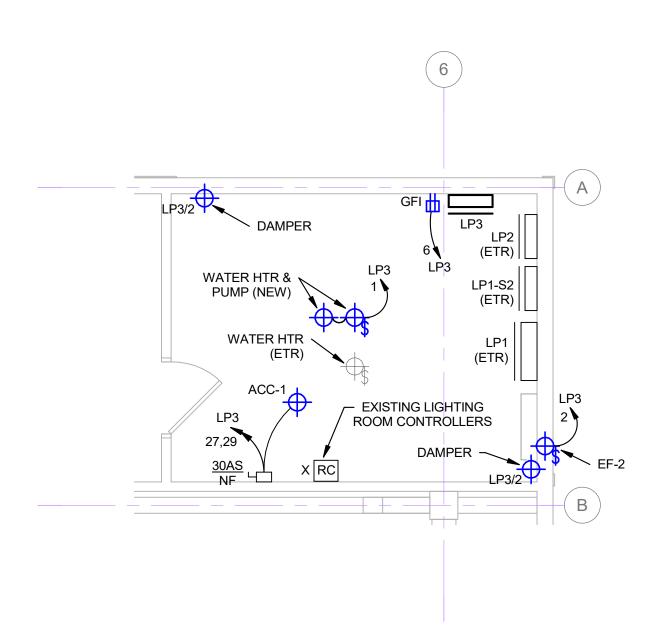



DLTS <u>208Y/120V</u> IS RATING <u>100A</u>	PANEL <u>LP3</u> LOCATION <u>MEZZ ELEC RM</u>									IC RATING <u>10K</u> TYPE		
IN BKR MLO										MTG SURFACE		
LOCATION		VATTAG Вф	Е	CIR	BKR		BKR	CIR	V	VATTAG Вф	Е	LOCATION
WATER HEATER & PUMP	Аф	БΨ	CΨ	1	20GF		20	2	ΑΨ	БΨ	- ΟΨ	MECH ROOM EXHAUST FAN
RESTROOM RECP.				3	2001		20GF	4				WASHING MACHINE
RESTROOM RECP.				5	20		20	6				MECH ROOM RECP.
RESTROOM REST.				7	20		20	8				WEST ROOM REST.
FAN COILS				9	15		30	10				DRYER
SPARE				11	20		20	12				SPARE
SPARE				13	20	•	20	14				SPARE
SPARE				15	20	++	20	16				SPARE
SPARE				17	20	++++	20	18				SPARE
SPARE				19	20	•	20	20				SPARE
SPACE				21		+		22				SPACE
SPACE				23		++++		24				SPACE
SPACE				25		•		26				SPACE
ACC-1				27	25	+		28				SPACE
ACC-1				29	25			30				SPACE
SUBTOTALS												



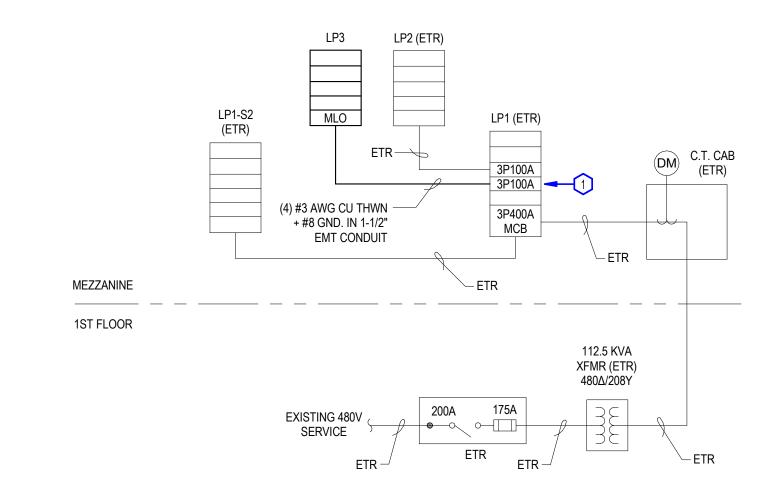





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> INTERIOR RENOVATIONS

Project Address:

CANALSIDE 44 PRIME ST. BUFFALO, NY 14202

Drawing History: # Date Description

Project Status: NOT FOR CONSTRUCTION

Sheet Title: MEZZANINE POWER

PLAN AND PANEL SCHEDULE

E102